



Date: 2/21/25

**2025 Water Main Improvement Projects:
La Cuesta Drive Water Main**

ADDENDUM NO. 1

The following clarifications and revisions are hereby incorporated in the Contract Documents, Construction Specifications and Plans for the project entitled, "2025 Water Main Improvement Projects, Scotts Valley Water District":

CONTRACT DOCUMENTS, CONSTRUCTION SPECIFICATIONS AND PLANS

CONTRACT DOCUMENTS:

Section 1 – Bid Documents: 1-C Bid Forms, Page 10,

Delete: Entire Page 10

Substitute: Revised Page 10 Attached

There was an error in the length on line item No. 3 – 8-inch Pipeline. Revised length is 1,447 Linear feet. Project begins at Station at Station 0+96. Stationing ends at 15+46. Point-of-Connection is 3-feet from ending station. $1,546 - 96 - 3 = 1,447$ linear feet.

CONTRACT PLANS:

La Cuesta Drive

Sheet C1.3 - Plan and Profile (Sheet 4 of 7),

Delete: Entire Sheet

Substitute: Revised Sheet C1.3 – Addendum 1, dated 02-20-2025

There was an error in the length of pipe in the plan view. Enlargement length has been revised to 43-LF. Length of pipe from Enlargement to Station 5+08 has been revised to 367-LF.

Sheet C1.4 - Point of Connection Enlargements (Sheet 5 of 7),

Delete: Entire Sheet

Substitute: Revised Sheet C1.4 – Addendum 1, dated 02-20-2025

There was an error in the length of pipe in the Enlargement Detail No. 1 – Point of Connection Quarterhorse Lane. Pipe length has been revised to 110-LF. Length of pipe for Enlargement Detail No. 3 – Point of Connection Altenitas Road has been revised to 43-LF.

C1.1 – Pipe length = 350-FT (Station 10+85 to Enlargement)

C1.2 – Pipe length = 577-FT (Station 5+08 to Station 10+85)

C1.3 – Pipe length = 43-FT (enlargement) – **Addendum No. 1**

Pipe length = 367-FT (enlargement to Station 5+08) – **Addendum No. 1**

C1.4 – Pipe length = 110-FT (enlargement No. 1) - **Addendum No. 1**
1,447 - FT

A copy of this letter containing the signature of an authorized agent of the Bidder and acknowledging Addendum No. 1 must be attached to the Bidder's proposal.

SCOTTS VALLEY WATER DISTRICT

Nate Gillespie
Operations Manager

ACKNOWLEDGMENT:

This Addendum No. 1 is hereby acknowledged and is attached to our proposal.

By: _____
(Authorized Agent's Signature)

Agent _____
(Print Authorized Agent's Name)

Bidder: _____
(Print Company Name)

LA CUESTA DRIVE

Item No.	Description	Measure Payment Reference	Bid Quantity	Unit	Unit Bid Price (Figures)	Total Bid Amount (Figures)
1	Mobilization	§3-A.01.G	1	LS	\$ _____	\$ _____
2	Traffic Control	§3-A.05. J	1	LS	\$ _____	\$ _____
3	8-inch Pipeline	§3-B.02. G	1,447	LF	\$ _____	\$ _____
6	Blow-off	§3-B.08. H (9)	1	LS	\$ _____	\$ _____
7	Air Relief Valve	§3-B.08. F (2)	2	LS	\$ _____	\$ _____
8	Slurry/Striping	§3-D.14. B (4)	33,000	SQ FT	\$ _____	\$ _____
					Sub Total:	\$ _____

Total Bid Price (Belair & La Cuesta):	\$ _____
---------------------------------------	----------

Total Base Bid Price in Words:

_____ Dollars \$ _____

All bid entries must be filled in.


Addenda Received and Reviewed:

(Indicate with check marks in respective boxes)

Addenda Number and Date


	Reviewed _____
	Reviewed _____
	Reviewed _____

The undersigned agrees that the enclosed cash deposit, cashier’s check, certified check, or surety bond accompanying this bid shall be left on deposit with the District, that its amount is the measure of the liquidated damages which the District will sustain by the default of the undersigned through failure to execute and deliver the above agreement, insurance and bonds within ten (10) calendar days of written notice of the award of the contract and the money or

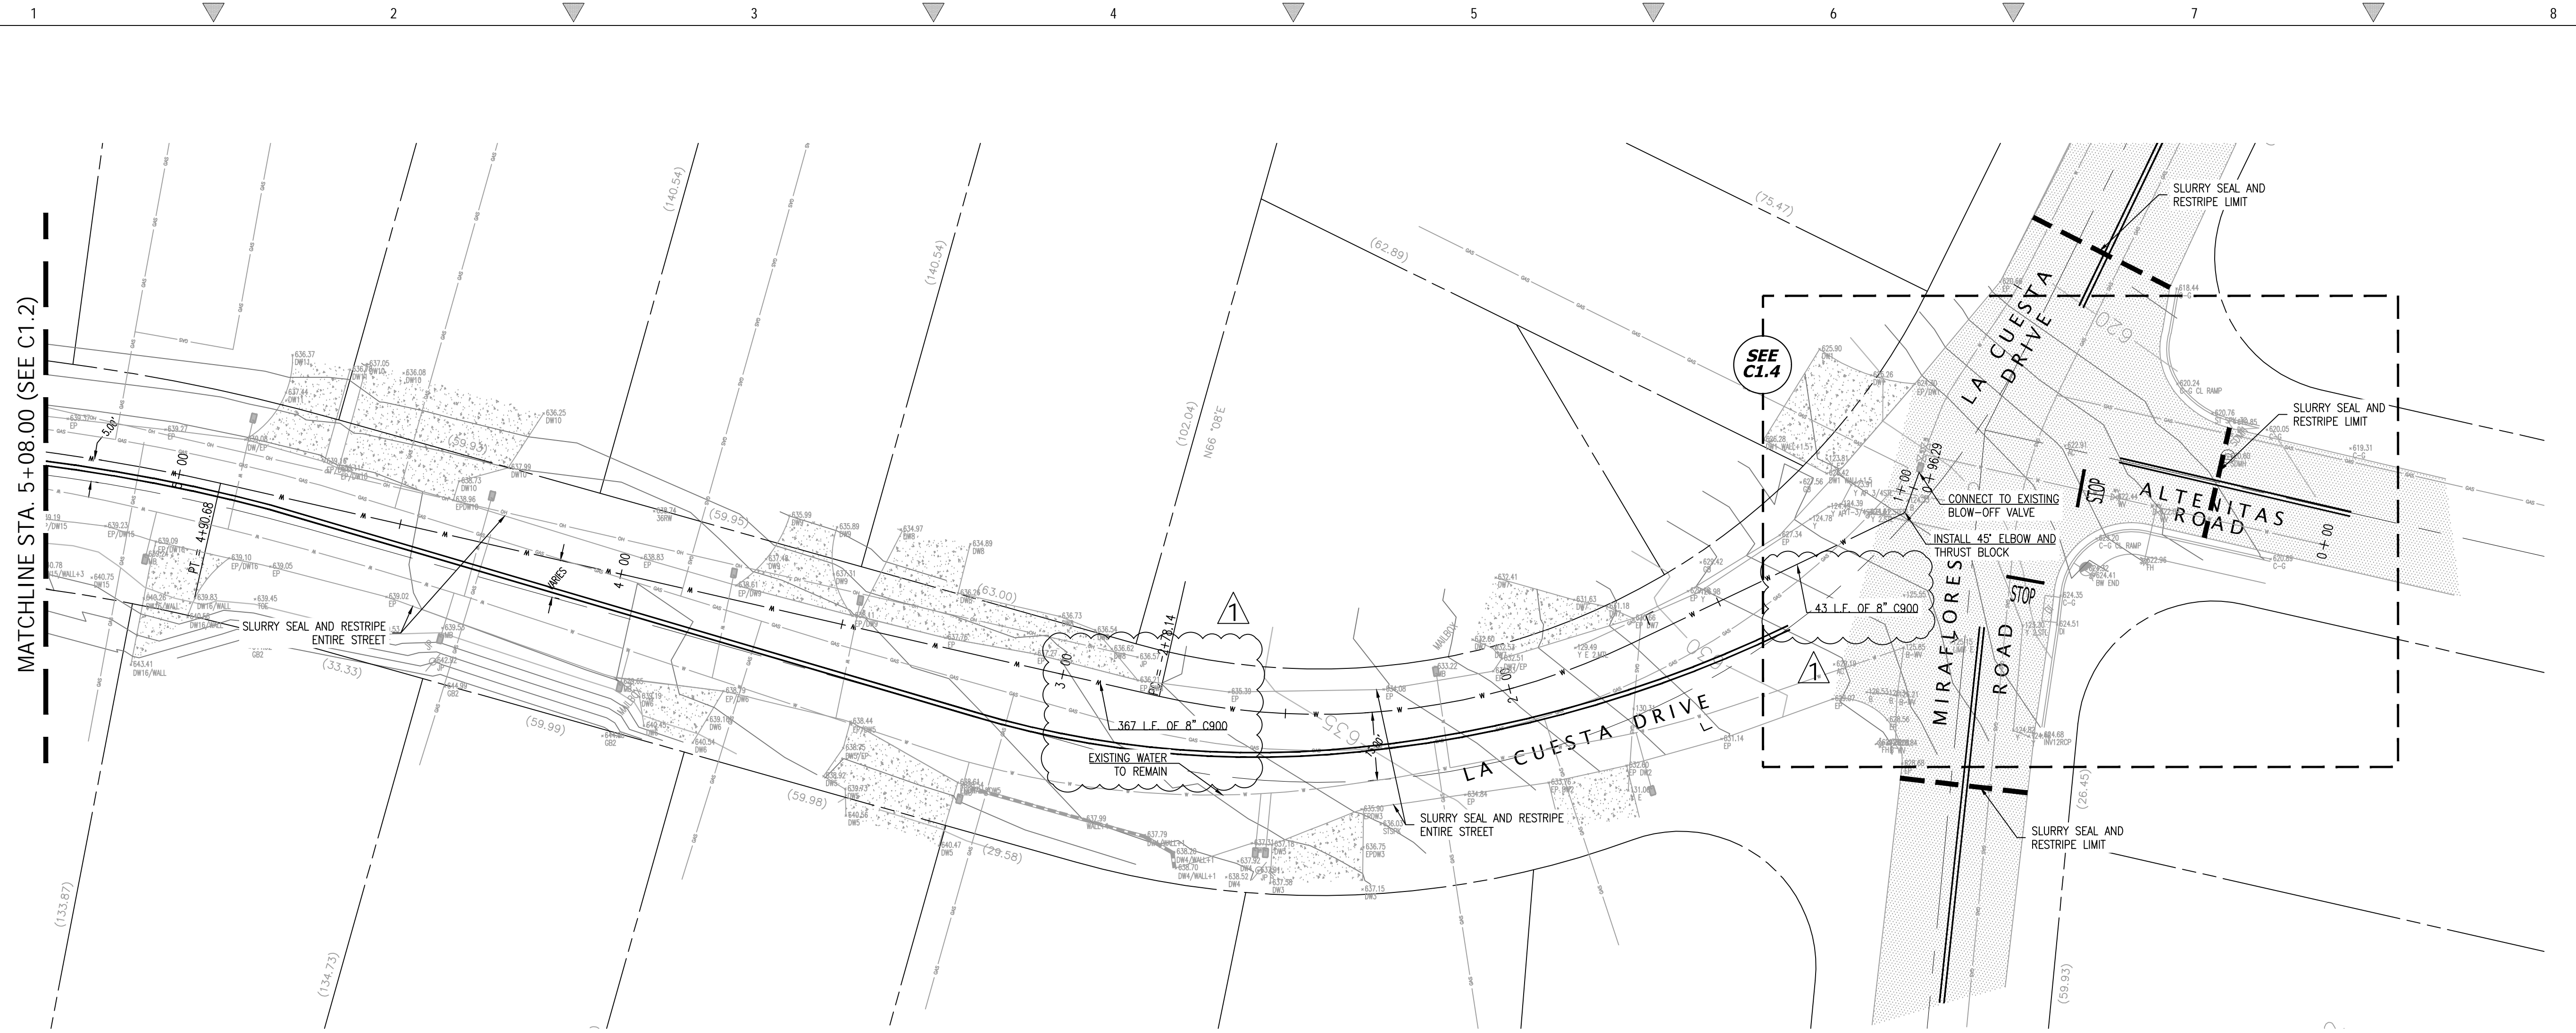


1 PLAN - STA.:1+39.12 - 5+08.00

Scale: 1"=20'

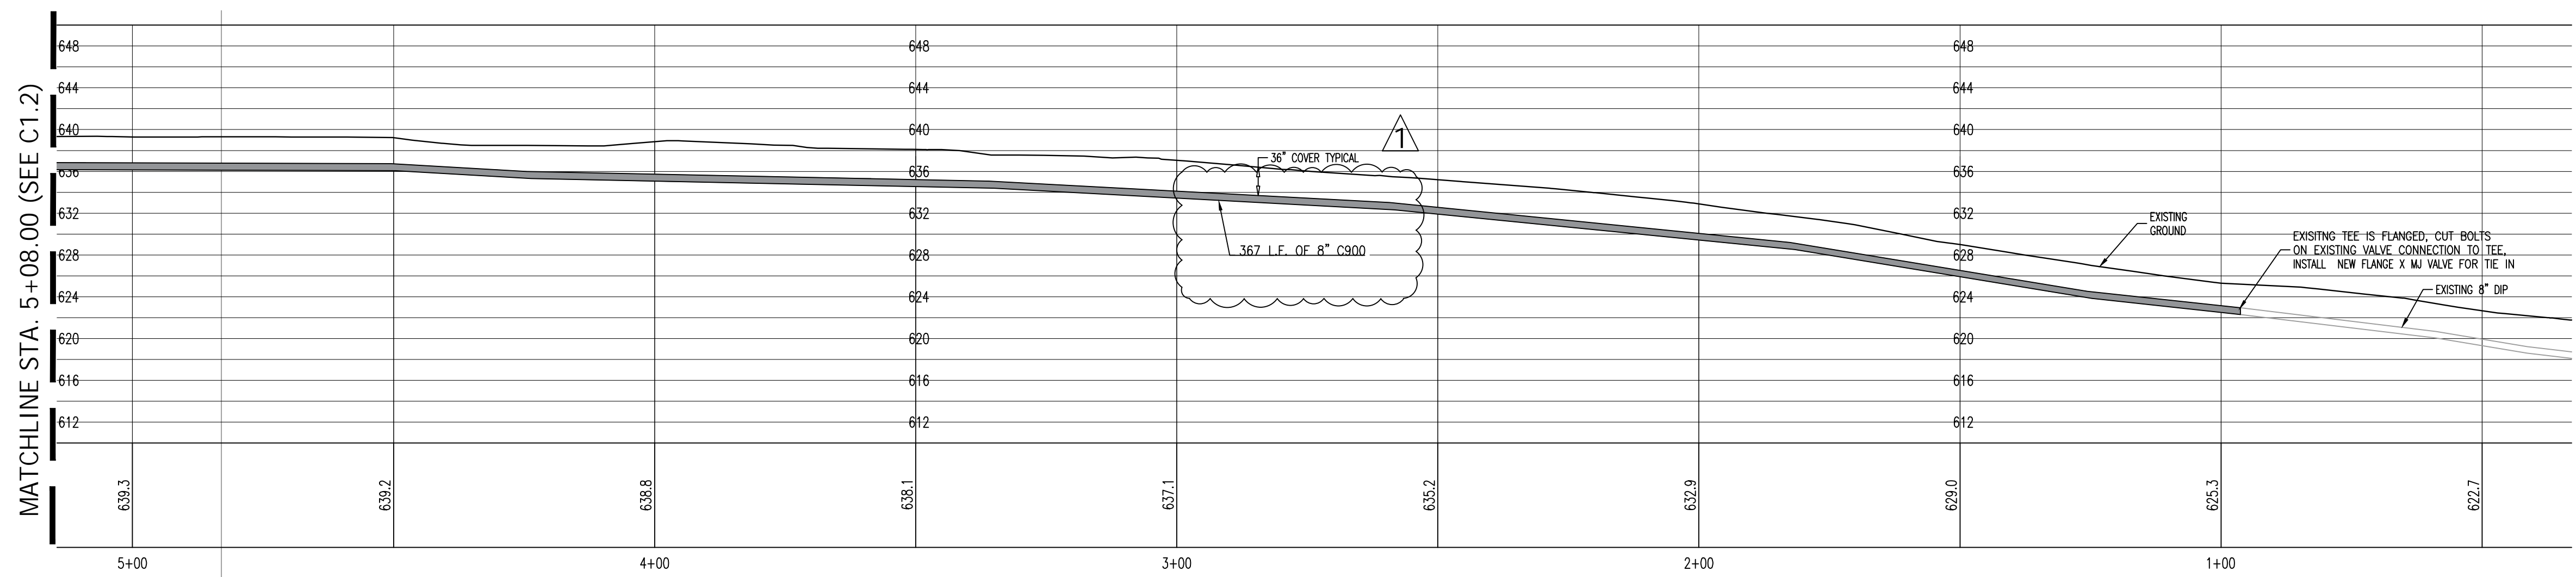

2 PROFILE - STA.:1+39.12 - 0+96.29

Scale: 1"=20'

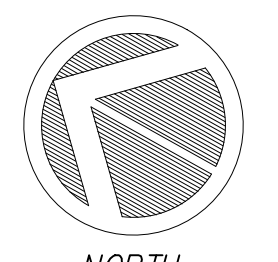

REVISIONS	BY
1	JB
ADDENDUM 1 02.20.2025	

PLAN AND PROFILE




C2G / CIVIL CONSULTANTS GROUP, INC.
 Engineers/Planners
 4444 Scotts Valley Drive / Suite 6
 Scotts Valley, CA 95066
 831.438.4420

SCOTT'S VALLEY WATER DISTRICT
 FIRE SUPPRESSION REINFORCEMENT MAIN
 LA CUESTA DRIVE, SCOTT'S VALLEY CA


Date:	03.06.2024
Scale:	1" = 20'
Drawn:	TC/JB
Job:	165-97
Sheet:	C1.3
Of 7 Sheets	

Drawing: Z:\Drawings\2024\165-97 - 2024 La Cuesta - Reinforcement Design\DWG\Sheets\165-97 - C1.3 - RFP.dwg
 Layout: C1.3 - RFP
 Last Saved: Fri Feb 21, 2025 - 8:46am
 Last Plotted: Fri Feb 21, 2025 - 8:46am
 By: Todd

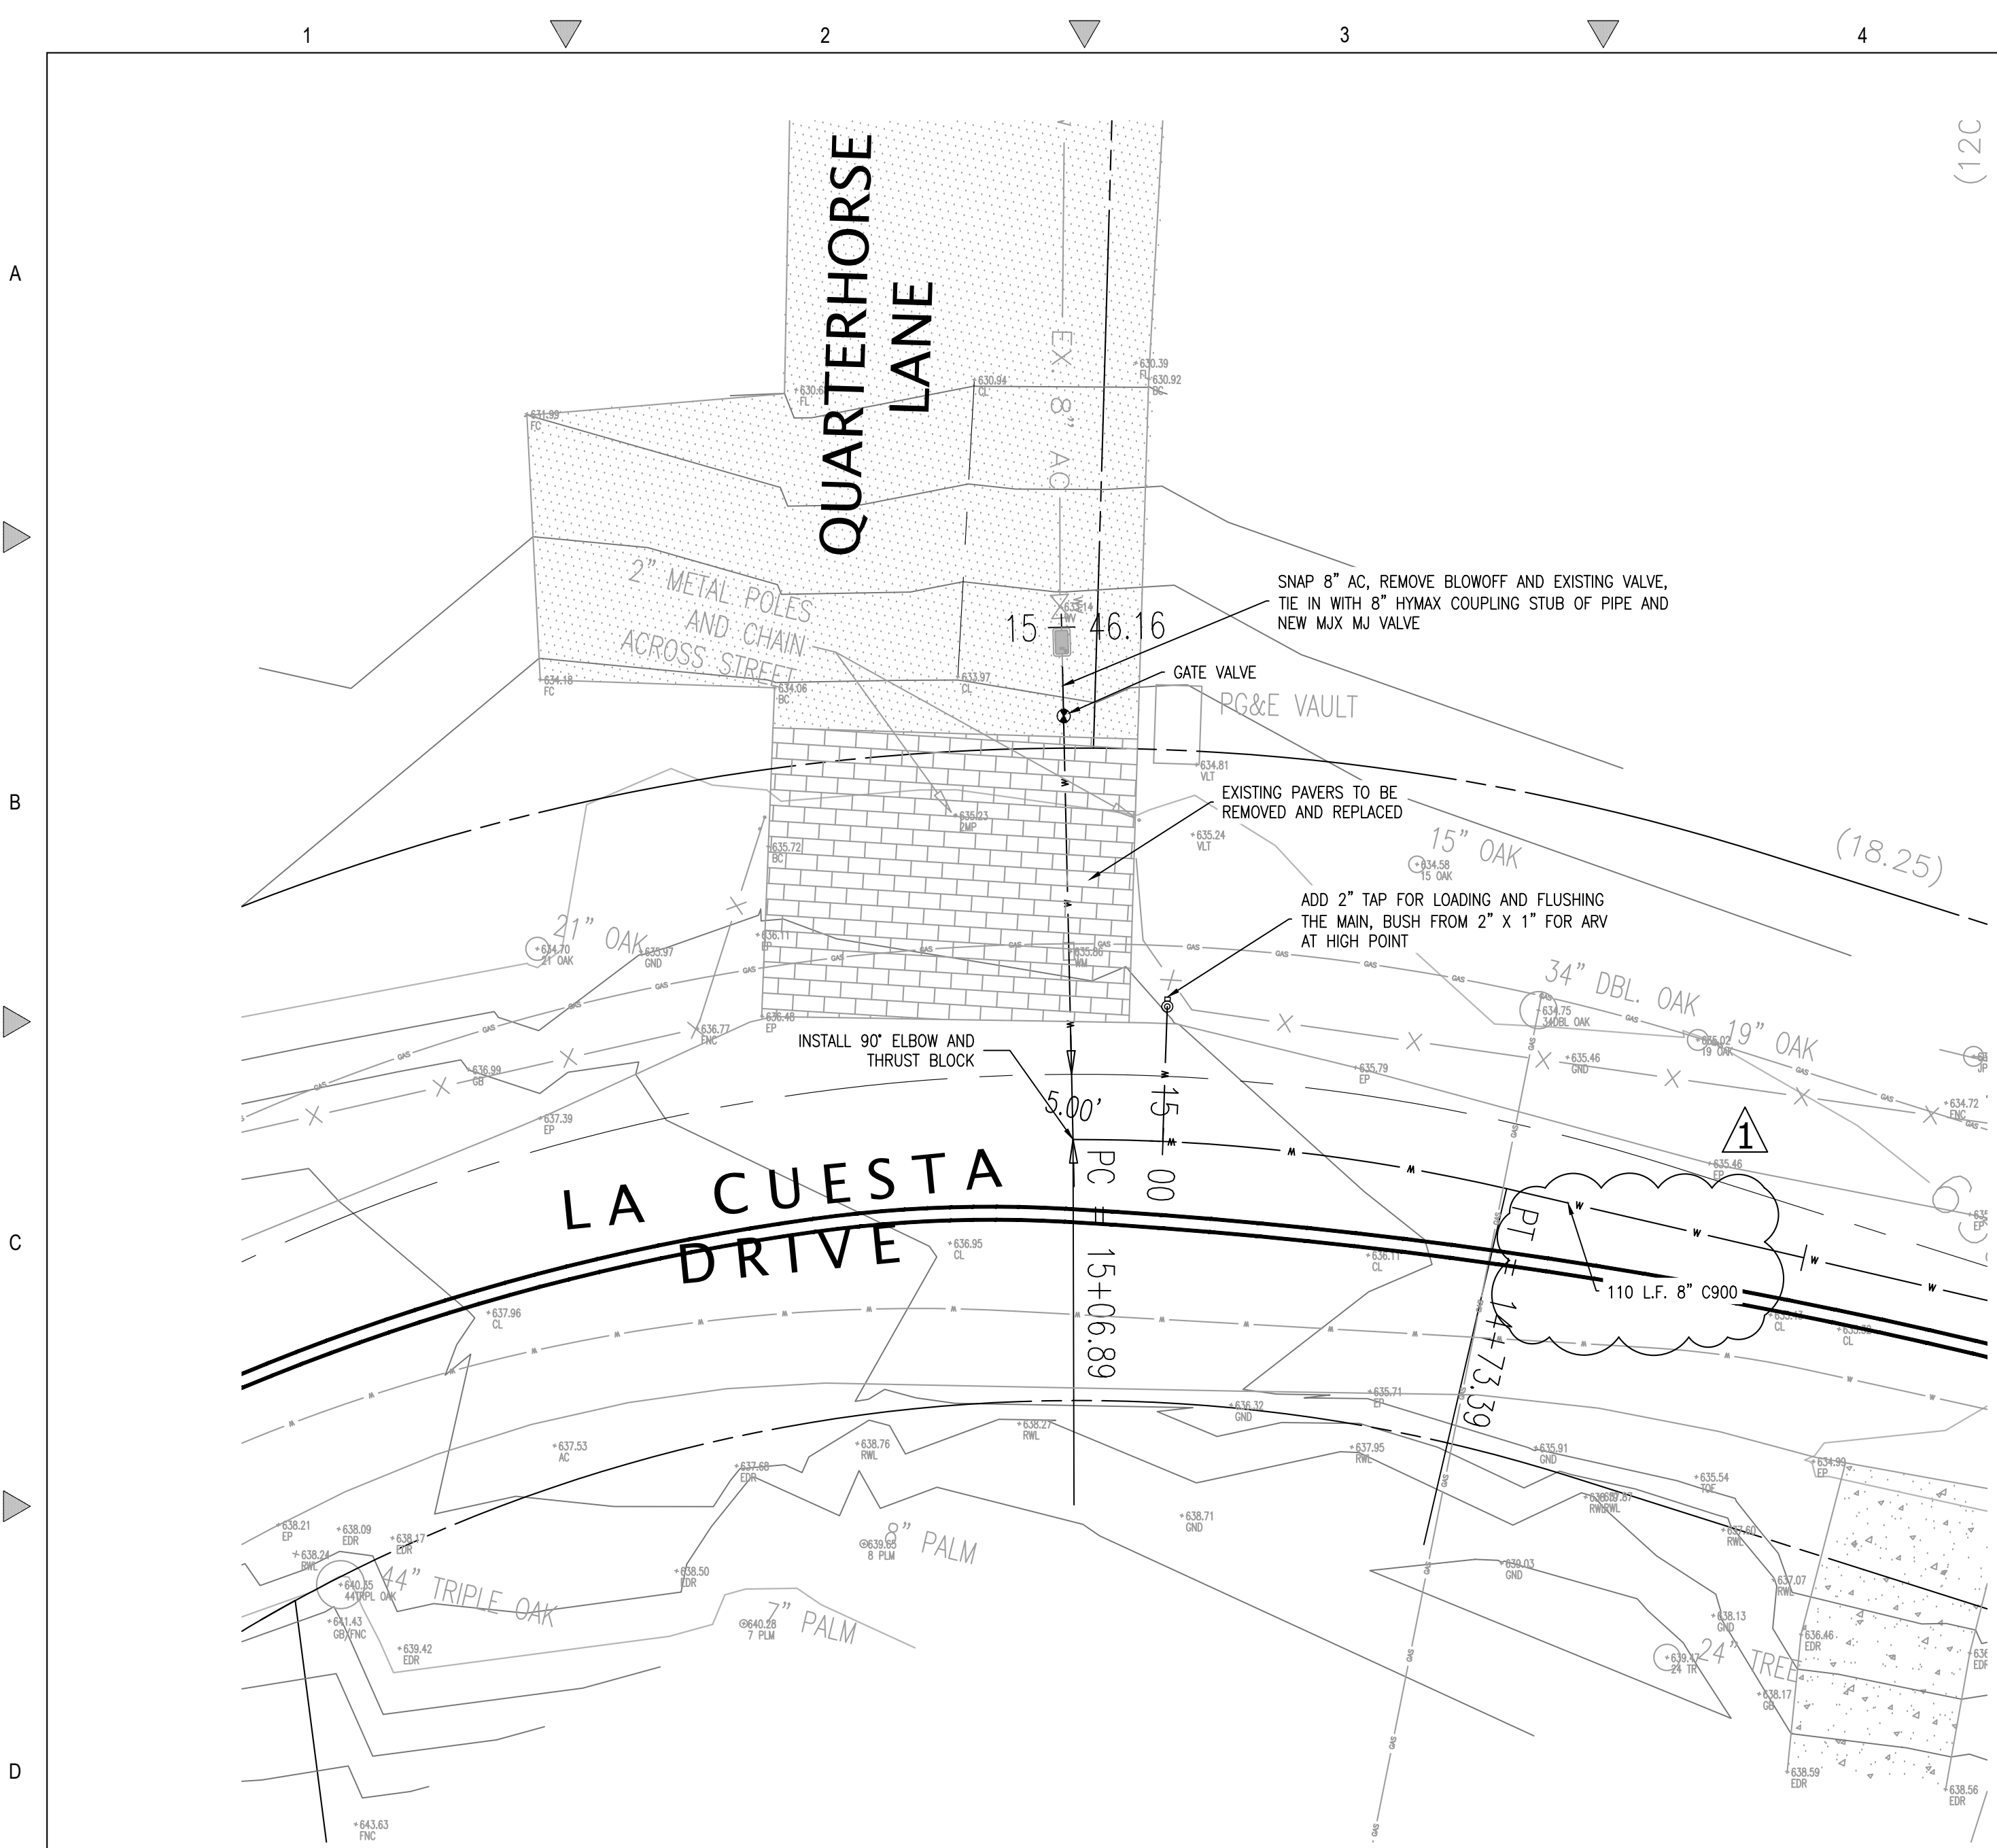


1 POINT OF CONNECTION QUARTERHORSE LANE

Scale: 1"=10'

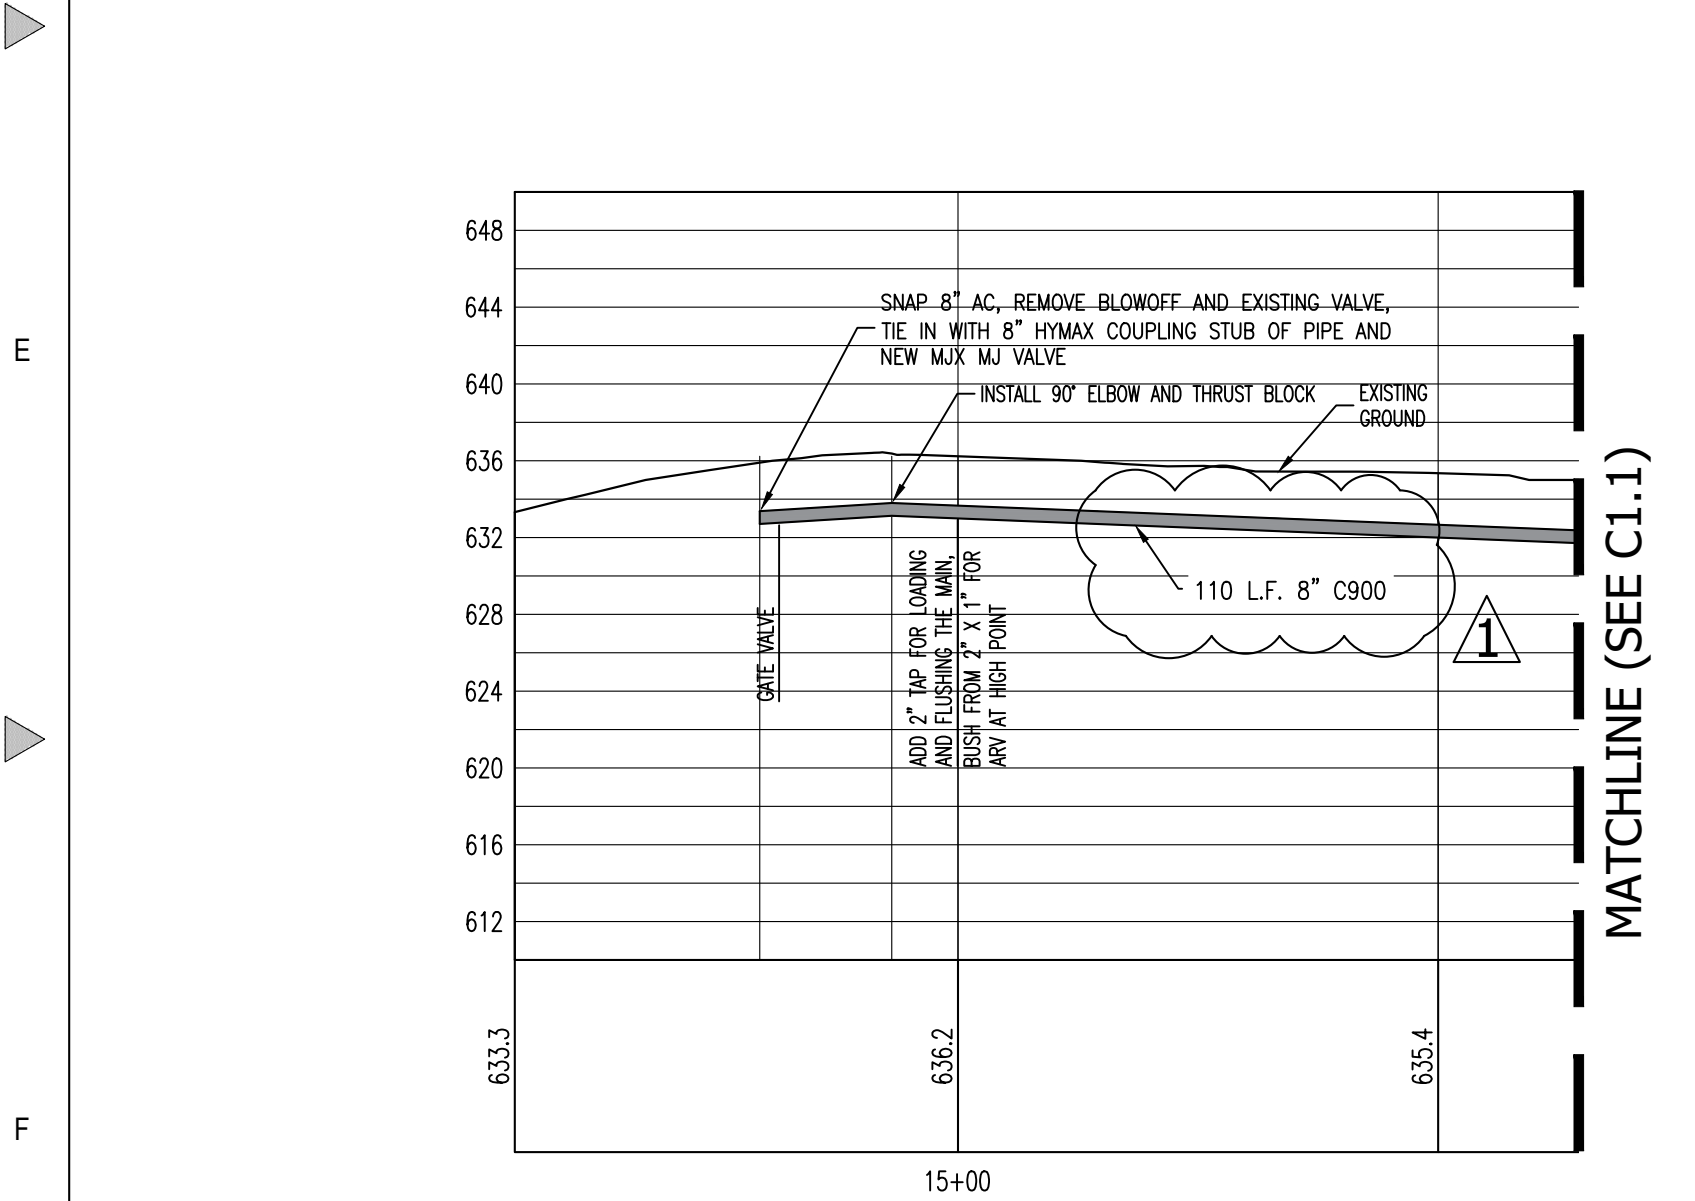


2 PROFILE - STA.:15+14.46 - 14+35.34

Scale: 1"=20'

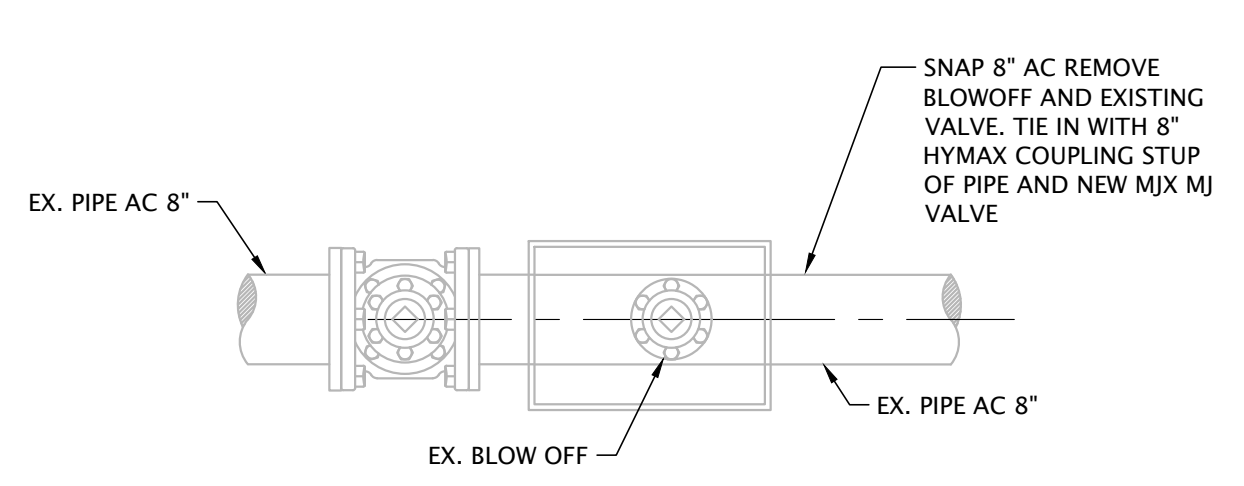


2A EXISTING QUARTERHORSE LANE P.O.C.

Scale: NTS

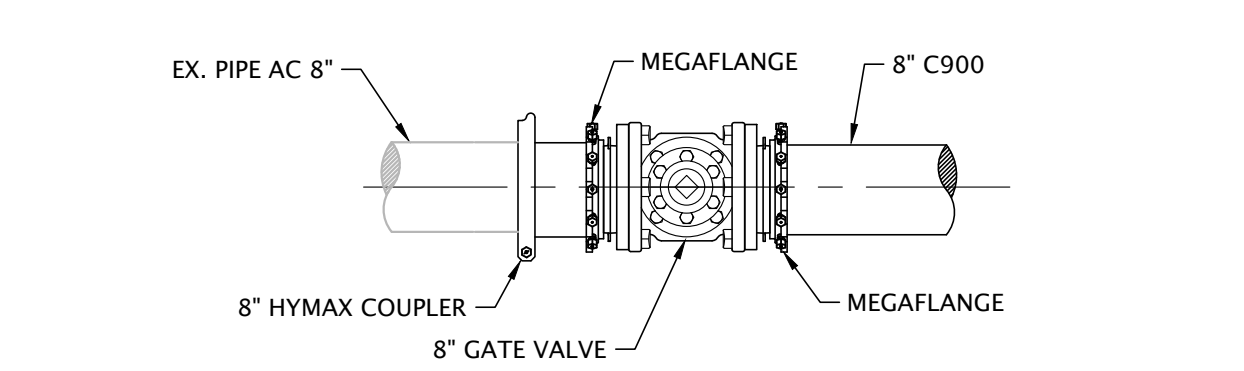



2B PROPOSED QUARTERHORSE LANE P.O.C.

Scale: NTS

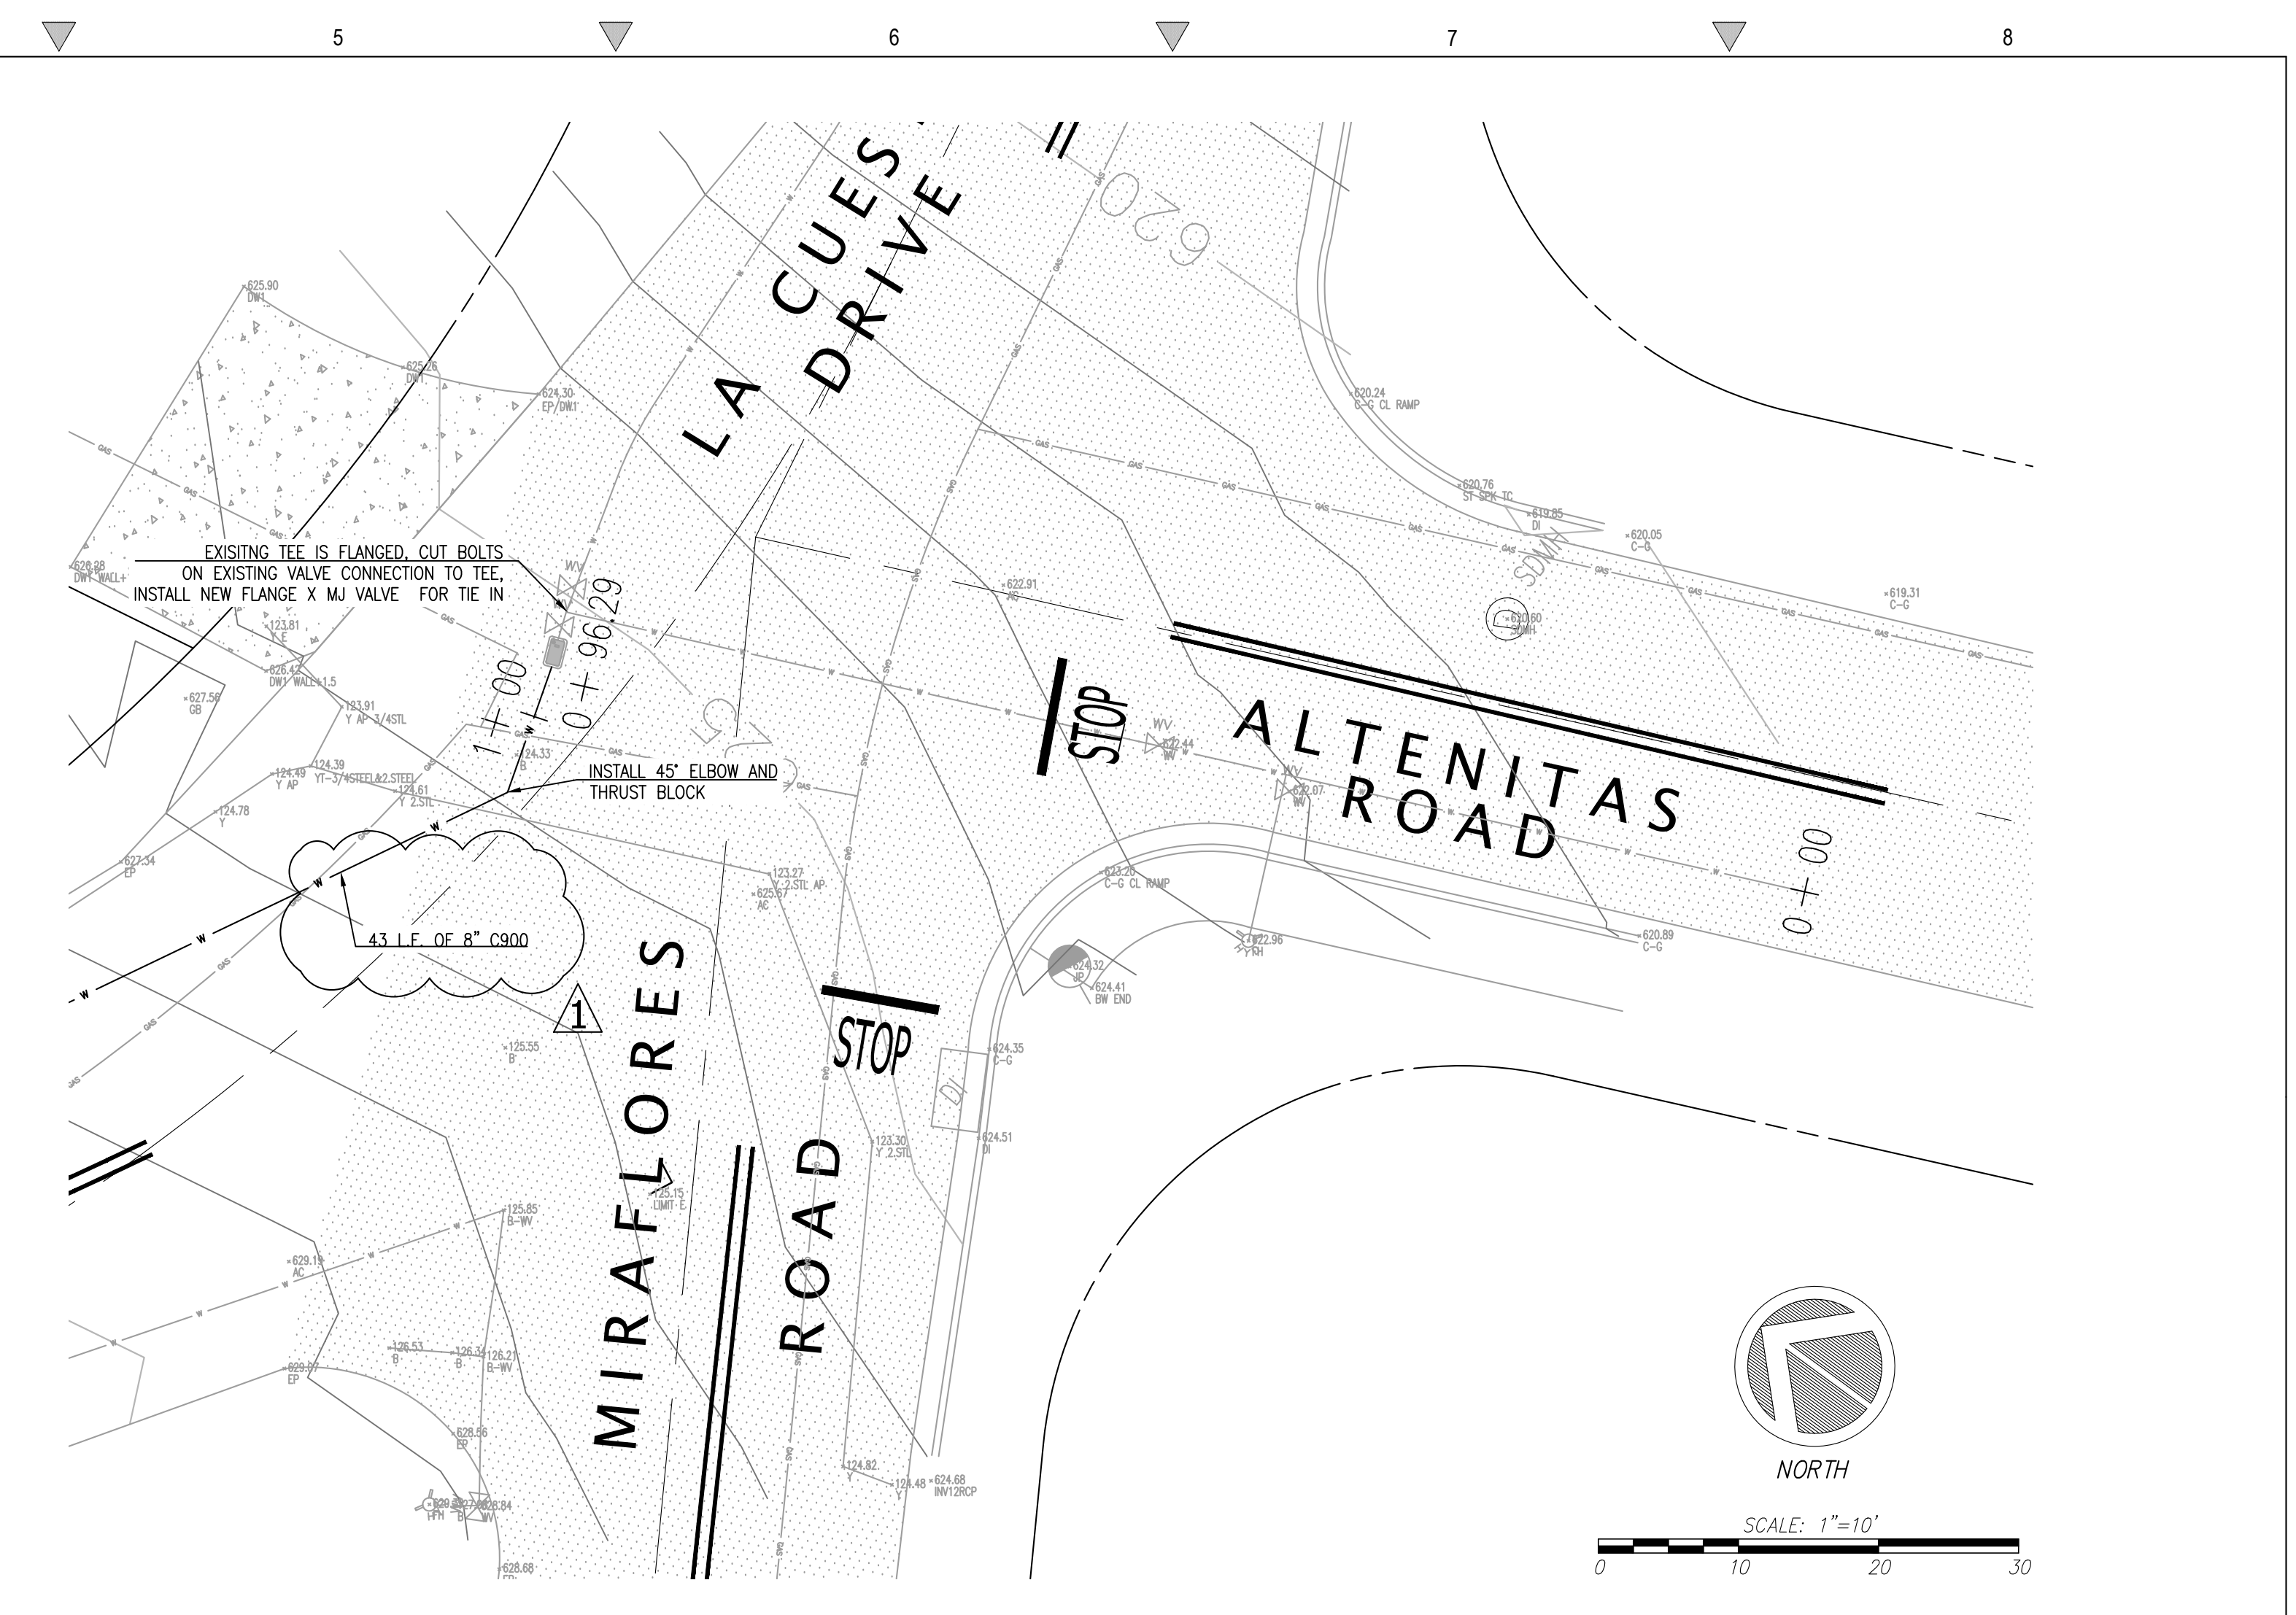


3 POINT OF CONNECTION ALTENITAS ROAD

Scale: 1"=10'

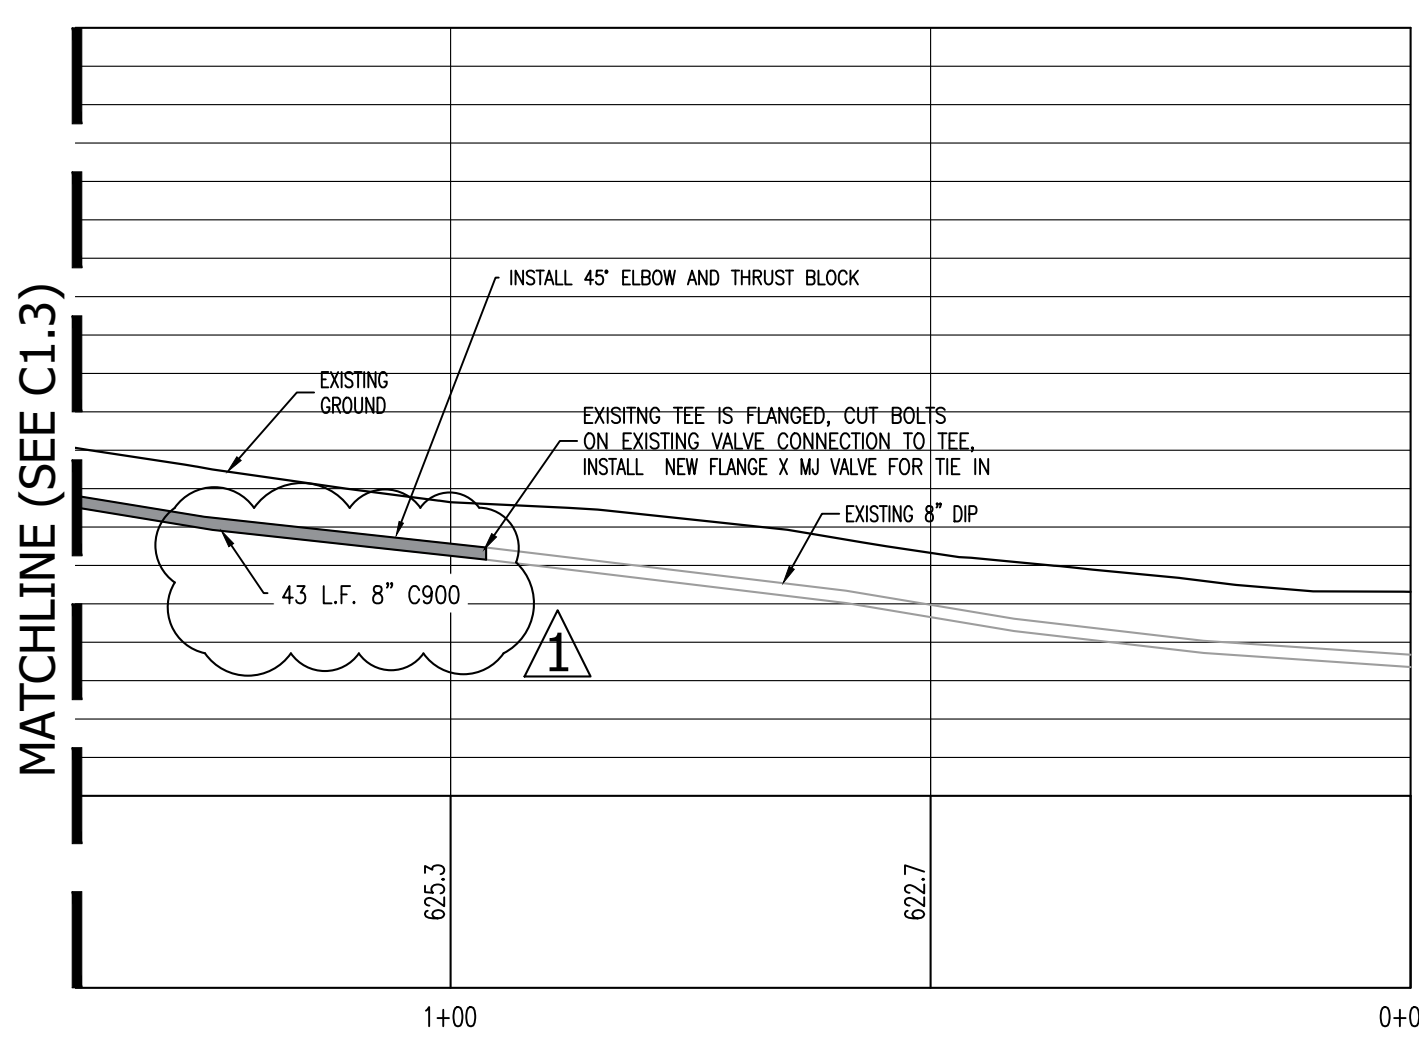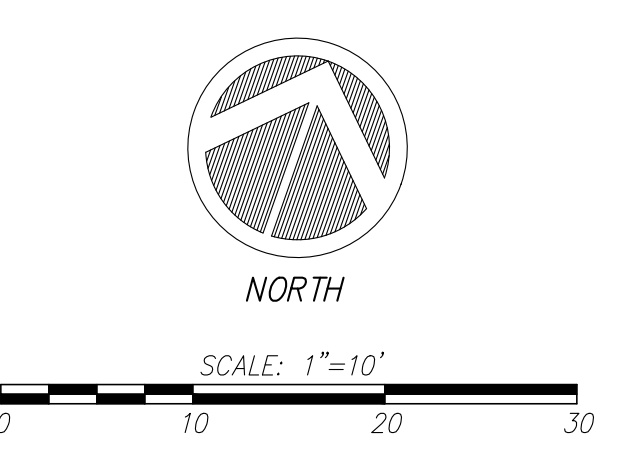


4 PROFILE - STA.:1+39.12 - 0+96.29

Scale: 1"=20'

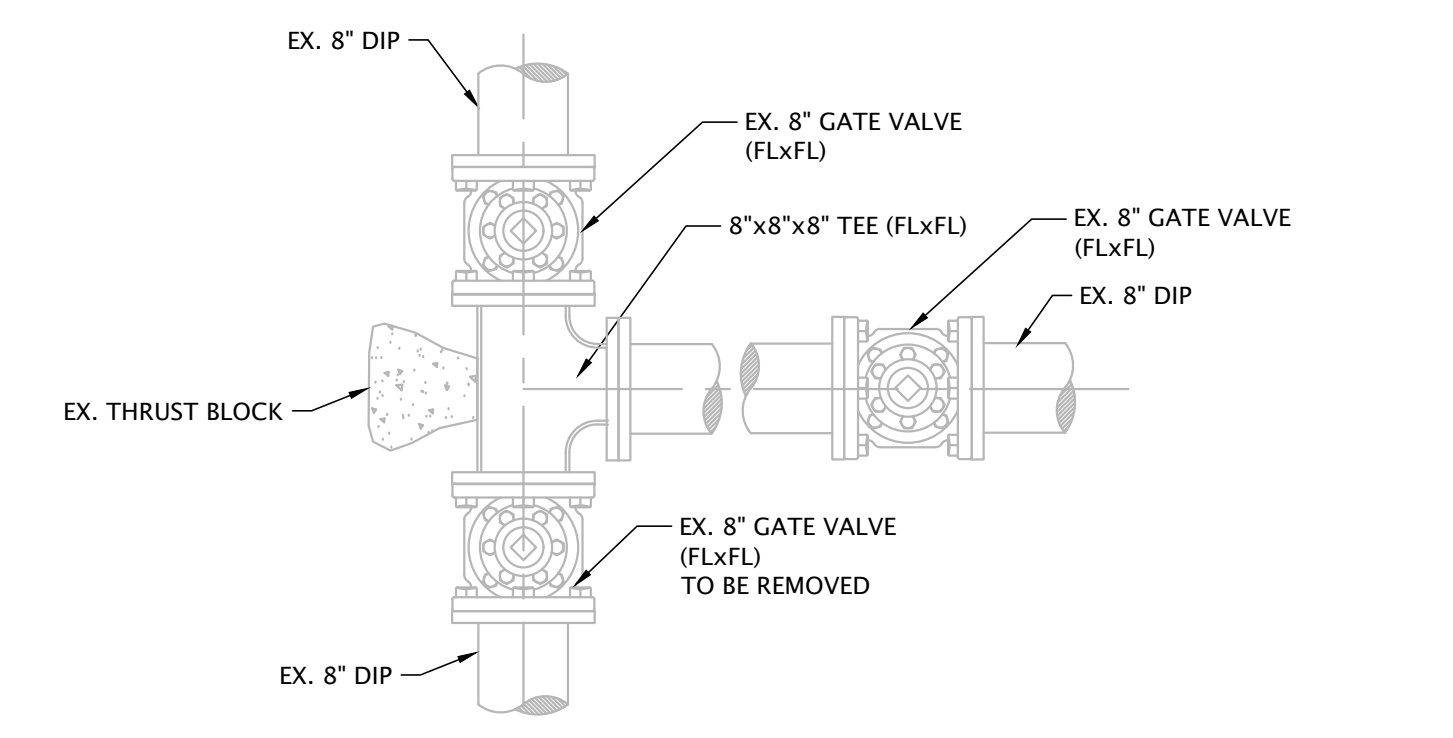

4A EXISTING LA CUESTA DRIVE P.O.C.

Scale: NTS

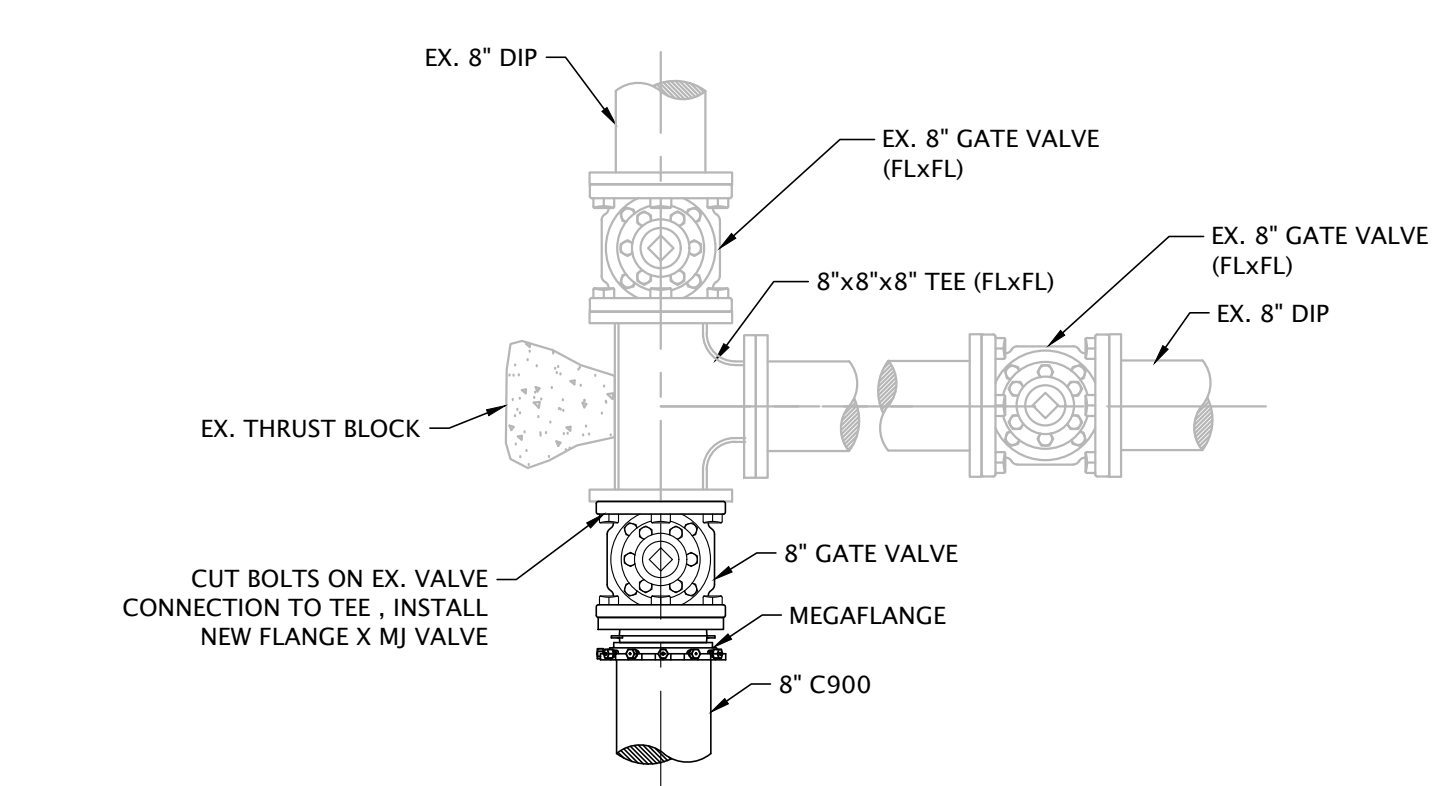


4B PROPOSED LA CUESTA DRIVE P.O.C.

Scale: NTS

REVISIONS	BY
1	JB
ADDENDUM 1	
02.20.2025	

POINT OF CONNECTION ENLARGEMENTS

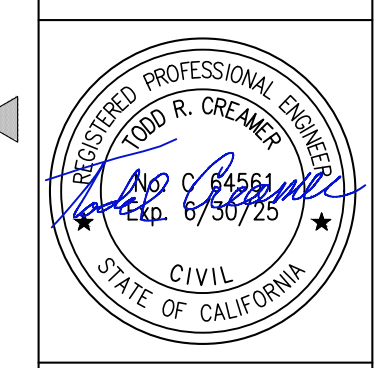

C2G / CIVIL CONSULTANTS GROUP, INC.
 Engineers/Planners
 4444 Scots Valley Drive / Suite 6
 Scots Valley, CA 95066
 831.438.4420

SCOTT'S VALLEY WATER DISTRICT
 FIRE SUPPRESSION REINFORCEMENT MAIN
 LA CUESTA DRIVE, SCOTT'S VALLEY CA

Date: 03.06.2024
 Scale: 1" = 10'
 Drawn: TC/JB
 Job: 165-97
 Sheet:
C1.4
 Of 7 Sheets