


# BETHANY DRIVE WATER MAIN IMPROVEMENTS

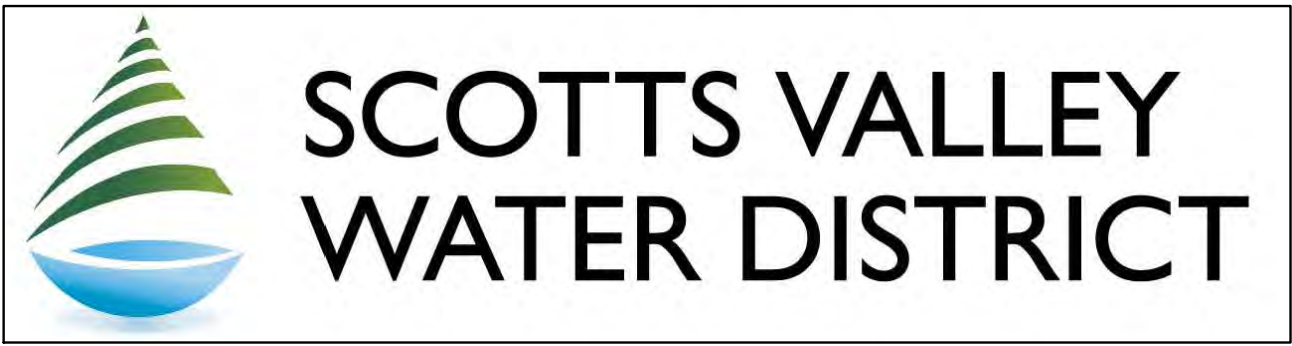

## INDEX OF SHEETS

- CO.1 - COVER
- C1.1 - EXISTING SITE - DEMOLITION PLAN
- C2.1 - SITE IMPROVEMENT PLAN
- C3.1 - STORM DRAIN PROFILE AND DETAILS

## SCOTTS VALLEY WATER DISTRICT:


2 CIVIC CENTER DRIVE  
SCOTTS VALLEY, CA 95066  
OFFICE: 831.438.2363

## CIVIL ENGINEER:

C2G/CIVIL CONSULTANTS GROUP, INC.  
4444 SCOTTS VALLEY DRIVE, STE. 6  
SCOTTS VALLEY, CA 95066  
OFFICE: 831.438.4420

## SURVEYOR:


ALPHA SURVEY  
4444 SCOTTS VALLEY DRIVE, STE 6  
SCOTTS VALLEY, CA 95066  
OFFICE: 831.438.4453

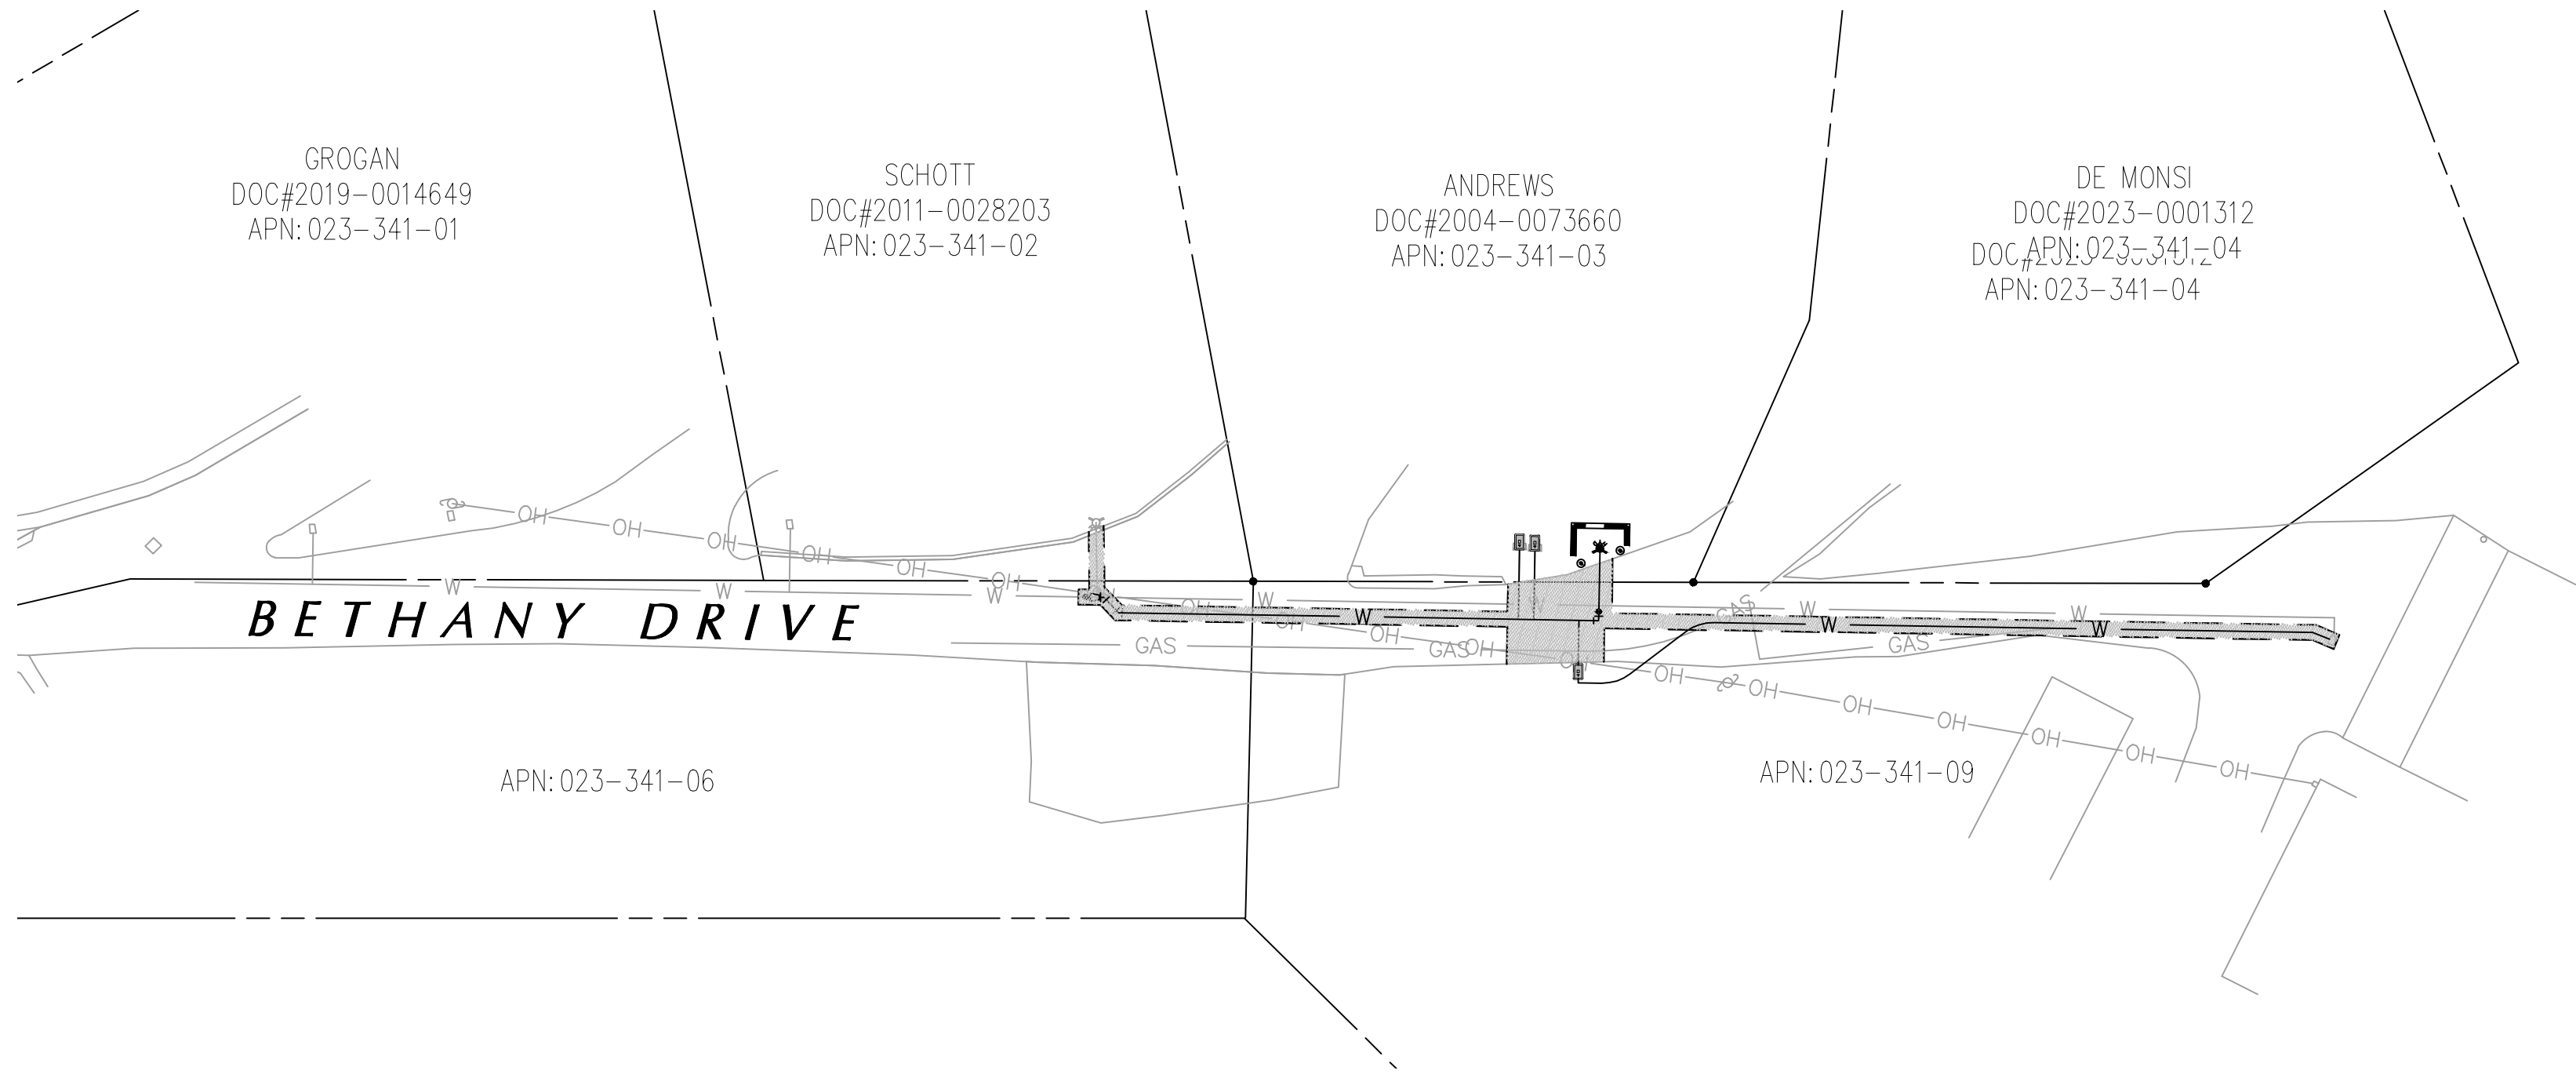

**SITE PLAN**  
SCALE: 1" = 20'



**VICINITY MAP**  
SCALE: N.T.S.

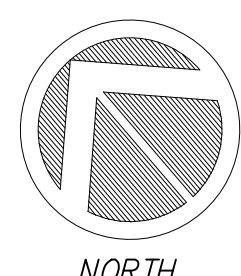

SCALE: 1" = 20'  
0 20 40 60

## CONTRACTOR RESPONSIBILITY

CONTRACTOR AGREES THAT HE SHOULD ASSUME SOLE AND COMPLETE RESPONSIBILITY FOR JOB SITE CONDITIONS, INCLUDING THE SAFETY OF ALL PERSONS AND PROPERTY, DURING THE COURSE OF CONSTRUCTION OF THIS PROJECT, AND THAT REQUIREMENT SHALL APPLY CONTINUOUSLY AND NOT BE LIMITED DURING WORKING HOURS. THE CONTRACTOR SHALL DEFEND, INDEMNIFY AND HOLD THE OWNER AND THE DESIGN PROFESSIONALS HARMLESS FROM ANY AND ALL LIABILITY, REAL OR ALLEGED, IN CONNECTION WITH THE PERFORMANCE OF WORK ON THIS PROJECT, EXCEPTING FOR LIABILITY ARISING FROM THE SOLE NEGLIGENCE OF THE OWNER OR DESIGN PROFESSIONAL.

## DISCREPANCIES

IF THERE ARE ANY DISCREPANCIES BETWEEN THE CONSTRUCTION DOCUMENTS AND EXISTING CONDITIONS WHICH WILL AFFECT THE WORK, THE CONTRACTOR SHALL BRING SUCH DISCREPANCIES TO THE DESIGN PROFESSIONAL FOR ADJUSTMENT BEFORE PROCEEDING WITH THE WORK. THE CONTRACTOR SHALL BE RESPONSIBLE FOR THE PROPER FITTING OF ALL WORK AND FOR THE COORDINATION OF ALL TRADES, SUBCONTRACTORS, AND PERSONS ENGAGED UPON THIS CONTRACT.

## EROSION CONTROL NOTE

1. IT IS THE CONTRACTOR'S RESPONSIBILITY TO PROVIDE AND MAINTAIN EROSION CONTROL MEASURES AS REQUIRED THROUGHOUT THE LIFE OF THE PROJECT IN CONFORMANCE WITH THE CITY OF SCOTTS VALLEY AND THE ASSOCIATION OF BAY AREA GOVERNMENTS
2. CONTRACTOR TO PROVIDE BACK-UP EROSION PREVENTION MEASURES (SOIL STABILIZATION) WITH SEDIMENT CONTROL MEASURES SUCH AS STRAW WATTLES, SILT FENCE, GRAVEL INLET FILTERS, AND/OR SEDIMENT TRAPS OR BASINS. ENSURE CONTROL MEASURES ARE ADEQUATE, IN PLACE, AND IN OPERABLE CONDITIONS. SEDIMENT CONTROLS, INCLUDING INLET PROTECTION, ARE NECESSARY BUT SHOULD BE A SECONDARY DEFENSE BEHIND GOOD EROSION CONTROL MEASURES.
3. ALL EROSION PREVENTION AND SEDIMENT CONTROL MEASURES SHALL BE MAINTAINED AND REPAIRED THROUGHOUT THE SEASON. REPLACEMENT SUPPLIES SHOULD BE KEPT ON SITE.
4. SITE INSPECTIONS SHALL BE CONDUCTED BEFORE AND AFTER EACH STORM EVENT, AND EVERY 24 HOURS FOR EXTENDED STORM EVENTS, TO IDENTIFY AREAS THAT CONTRIBUTE TO EROSION AND SEDIMENT PROBLEMS OR ANY OTHER POLLUTANT DISCHARGES. IF ADDITIONAL MEASURES ARE NEEDED, REVISE THE EROSION CONTROL PLAN AND IMPLEMENT THE MEASURES IMMEDIATELY. DOCUMENT ALL INSPECTION FINDINGS AND ACTIONS TAKEN.
5. CONTRACTOR SHALL USE BEST MANAGEMENT PRACTICES DURING CONSTRUCTION FOR CONTROL OF STORM WATER RUNOFF (E.G. GRAVEL BAGS AT CATCH BASIN INLETS).

## UNDERGROUND NOTES

1. SANITARY SEWER TRENCH BACKFILL SHALL CONFORM TO CITY OF SCOTTS VALLEY SEWER PIPE TRENCH DETAIL.
2. JETTING OF BACKFILL MATERIALS TO ACHIEVE COMPACTION IS NOT ALLOWED.
3. ALL THE WATER PIPING SHALL BE AWWA CLASS 200 DR14 305 PSI OR EQUIVALENT ALL VALVES, ANGLES, AND THRUST BLOCKS SHALL BE INSTALLED PER CURRENT CPC SPECIFICATIONS.
4. ALL FIRE SERVICE PIPING AND APPURTENANCES SHALL CONFORM TO NFPA STANDARDS AND SPECIFICATIONS
5. ANY EXISTING UTILITIES THAT ARE REQUIRED TO BE RELOCATED AS A PART OF THIS CONSTRUCTION SHALL BE RELOCATED AT THE DEVELOPER'S EXPENSE.

## UNAUTHORIZED CHANGES AND USES

CAUTION: THE ENGINEER PREPARING THESE PLANS WILL NOT BE RESPONSIBLE FOR, OR LIABLE FOR, UNAUTHORIZED CHANGES TO OR USES OF THESE PLANS. ALL CHANGES TO THE PLANS MUST BE IN WRITING AND MUST BE APPROVED BY THE PREPARER OF THE PLANS

THE WITHIN PLANS ARE COPYRIGHTED AS AN UNPUBLISHED WORK BY C2G/CIVIL CONSULTANTS GROUP, INC. ALL IDEAS, DESIGNS, ARRANGEMENTS AND PLANS INDICATED OR REPRESENTED BY THESE DRAWINGS ARE OWNED BY, AND THE PROPERTY OF C2G/CIVIL CONSULTANTS GROUP, INC. AND WERE CREATED, EVOLVED AND DEVELOPED FOR USE ON, AND IN CONNECTION WITH, THE SPECIFIED PROJECT. NONE OF SUCH IDEAS, DESIGNS, ARRANGEMENTS OR PLANS SHALL BE USED BY OR DISCLOSED TO ANY PERSON, FIRM OR CORPORATION FOR ANY PURPOSE WHATSOEVER WITHOUT THE WRITTEN PERMISSION OF C2G/CIVIL CONSULTANTS GROUP, INC. ©2023 TODD R. CREAMER, D.B.A. AS C2G/CIVIL CONSULTANTS GROUP, INC.

## NOTES

CONTRACTOR SHALL VERIFY ALL UTILITY LOCATIONS. CALL USA (800) 227-2600. CONTRACTOR TO NOTIFY ENGINEER OF ANY APPARENT CONFLICTS FOR RESOLUTION PRIOR TO START OF CONSTRUCTION.

## GENERAL NOTES

1. NO CHANGE TO THE PLANS SHALL BE PERMITTED WITHOUT PRIOR WRITTEN APPROVAL BY THE OWNER OR OWNERS REPRESENTATIVES AND SCOTT'S VALLEY WATER DISTRICT.
2. CONTRACTOR SHALL VERIFY LOCATIONS, ELEVATIONS AND INVERTS OF EXISTING UTILITY PRIOR TO COMMENCEMENT OF WORK AND SHALL NOTIFY OWNER OR OWNERS REPRESENTATIVES OF VARIANCE FROM THOSE SHOWN ON THE PLANS.
3. UNDERGROUND FACILITIES AND UTILITIES HAVE BEEN SHOWN BASED ON RECORD DRAWINGS AND VISIBLE EVIDENCE FOUND IN FIELD. NO WARRANTY IS MADE REGARDING THE COMPLETENESS OR ACCURACY OF SUCH INFORMATION. PRIOR TO CONSTRUCTION, DETERMINE THE EXACT LOCATION OF UNDERGROUND FACILITIES AND UTILITIES, AND PRESERVE SAME FROM DAMAGE. PRIOR TO CONSTRUCTION, VERIFY LOCATION AND ELEVATION OF EXISTING UNDERGROUND UTILITIES AT THE CROSSING POINTS WITH PROPOSED UTILITIES. THE CONTRACTOR SHALL NOTIFY THE OWNER OR OWNERS REPRESENTATIVES IF CONDITIONS DIFFER FROM THOSE SHOWN ON THE DRAWINGS AND SHALL NOT BEGIN CONSTRUCTION UNTIL THE CHANGED CONDITION HAS BEEN EVALUATED. CONTACT UNDERGROUND SERVICES ALERT (USA) (1-800-227-2600) TWO (2) WORKING DAYS PRIOR TO DIGGING. REPAIR UNDERGROUND UTILITIES DAMAGED BY CONSTRUCTION OPERATIONS. CONTRACTOR SHALL BE RESPONSIBLE FOR ANY AND ALL DAMAGES ASSOCIATED WITH CONTRACTOR'S FAILURE TO EXACTLY LOCATED AND PRESERVE UNDERGROUND FACILITIES AND UTILITIES.
4. CONTRACTOR SHALL BE RESPONSIBLE FOR ALL COORDINATION WITH THE APPROPRIATE UTILITY COMPANIES AND/OR AGENCIES TO VERIFY THE EXISTENCE AND/OR LOCATION OF ALL UNDERGROUND UTILITIES PRIOR TO COMMENCEMENT OF WORK. AND SHALL NOTIFY U.S.A. @ (800) 227-2600 AT LEAST 48-HOURS IN ADVANCE OF EXCAVATION.
5. IF ANY INDICATIONS OF ARCHEOLOGICAL REMAINS ARE ENCOUNTERED DURING GRADING ACTIVITIES FOR ANY DEVELOPMENT WITHIN THE PROJECT SITE, ALL WORK SHALL BE HALTED WITHIN 200 FOOT RADIUS OF THE FIND. OWNER SHALL RETAIN A QUALIFIED ARCHEOLOGIST RETAINED TO DETERMINE THE NATURE OF THE DISCOVERY AND RECOMMEND APPROPRIATE EVALUATION PROCEDURES.

## CONSTRUCTION SURVEYING / STAKING

CONTRACTOR IS RESPONSIBLE TO PROVIDE ALL SURVEYING AND OR STAKING BY A LICENSED SURVEYOR FOR ALL CONSTRUCTION PURPOSES.

REVISIONS	BY

COVER




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 Engineers/Planners  
 4444 Scotts Valley Drive / Suite 6  
 Scotts Valley, CA 95066  
 831.438.4420

SCOTTS VALLEY WATER DISTRICT  
 BETHANY DRIVE  
 WATER MAIN IMPROVEMENTS

Date:	09.29.2023
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Job:	165.95
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	Of 3 Sheets



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**DEMOLITION & SITE PREPARATION NOTES:**

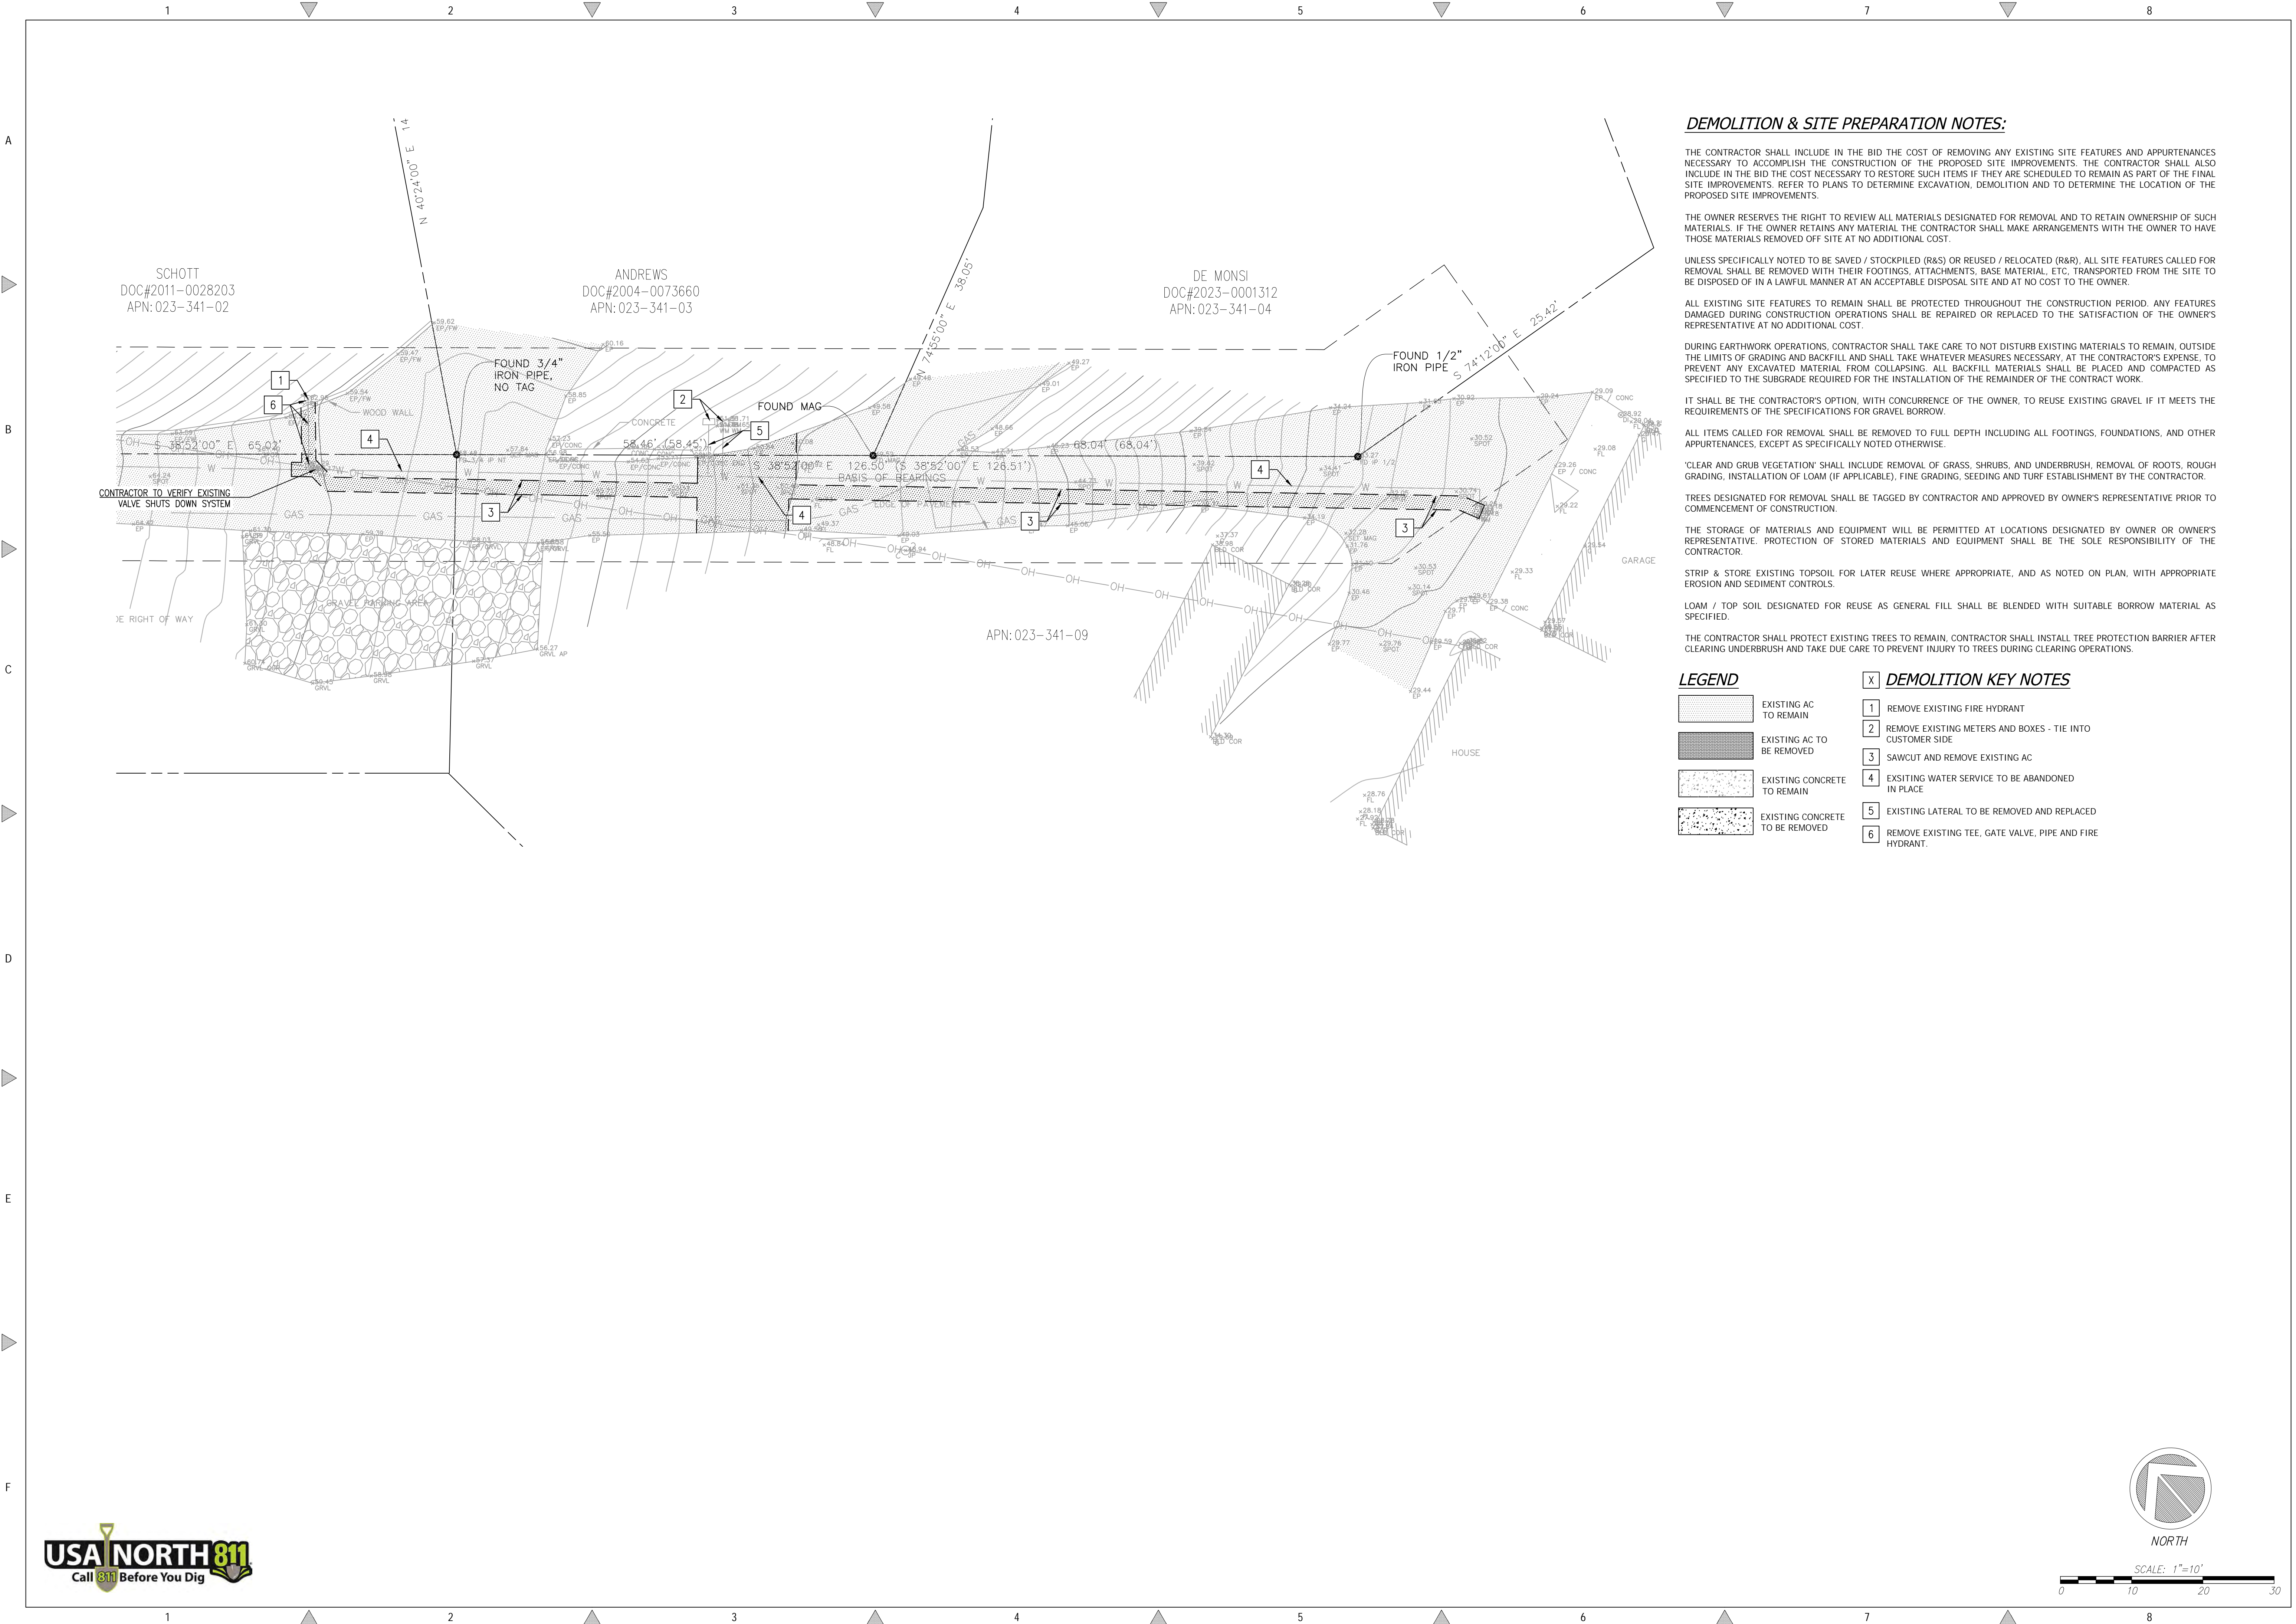THE CONTRACTOR SHALL INCLUDE IN THE BID THE COST OF REMOVING ANY EXISTING SITE FEATURES AND APPURTENANCES NECESSARY TO ACCOMPLISH THE CONSTRUCTION OF THE PROPOSED SITE IMPROVEMENTS. THE CONTRACTOR SHALL ALSO INCLUDE IN THE BID THE COST NECESSARY TO RESTORE SUCH ITEMS IF THEY ARE SCHEDULED TO REMAIN AS PART OF THE FINAL SITE IMPROVEMENTS. REFER TO PLANS TO DETERMINE EXCAVATION, DEMOLITION AND TO DETERMINE THE LOCATION OF THE PROPOSED SITE IMPROVEMENTS.

THE OWNER RESERVES THE RIGHT TO REVIEW ALL MATERIALS DESIGNATED FOR REMOVAL AND TO RETAIN OWNERSHIP OF SUCH MATERIALS. IF THE OWNER RETAINS ANY MATERIAL THE CONTRACTOR SHALL MAKE ARRANGEMENTS WITH THE OWNER TO HAVE THOSE MATERIALS REMOVED OFF SITE AT NO ADDITIONAL COST.

UNLESS SPECIFICALLY NOTED TO BE SAVED / STOCKPILED (R&S) OR REUSED / RELOCATED (R&R), ALL SITE FEATURES CALLED FOR REMOVAL SHALL BE REMOVED WITH THEIR FOOTINGS, ATTACHMENTS, BASE MATERIAL, ETC. TRANSPORTED FROM THE SITE TO BE DISPOSED OF IN A LAWFUL MANNER AT AN ACCEPTABLE DISPOSAL SITE AND AT NO COST TO THE OWNER.

ALL EXISTING SITE FEATURES TO REMAIN SHALL BE PROTECTED THROUGHOUT THE CONSTRUCTION PERIOD. ANY FEATURES DAMAGED DURING CONSTRUCTION OPERATIONS SHALL BE REPAIRED OR REPLACED TO THE SATISFACTION OF THE OWNER'S REPRESENTATIVE AT NO ADDITIONAL COST.

DURING EARTHWORK OPERATIONS, CONTRACTOR SHALL TAKE CARE TO NOT DISTURB EXISTING MATERIALS TO REMAIN, OUTSIDE THE LIMITS OF GRADING AND BACKFILL AND SHALL TAKE WHATEVER MEASURES NECESSARY, AT THE CONTRACTOR'S EXPENSE, TO PREVENT ANY EXCAVATED MATERIAL FROM COLLAPSING. ALL BACKFILL MATERIALS SHALL BE PLACED AND COMPACTED AS SPECIFIED TO THE SUBGRADE REQUIRED FOR THE INSTALLATION OF THE REMAINDER OF THE CONTRACT WORK.

IT SHALL BE THE CONTRACTOR'S OPTION, WITH CONCURRENCE OF THE OWNER, TO REUSE EXISTING GRAVEL IF IT MEETS THE REQUIREMENTS OF THE SPECIFICATIONS FOR GRAVEL BORROW.

ALL ITEMS CALLED FOR REMOVAL SHALL BE REMOVED TO FULL DEPTH INCLUDING ALL FOOTINGS, FOUNDATIONS, AND OTHER APPURTENANCES, EXCEPT AS SPECIFICALLY NOTED OTHERWISE.

'CLEAR AND GRUB VEGETATION' SHALL INCLUDE REMOVAL OF GRASS, SHRUBS, AND UNDERBRUSH. REMOVAL OF ROOTS, ROUGH GRADING, INSTALLATION OF LOAM (IF APPLICABLE), FINE GRADING, SEEDING AND TURF ESTABLISHMENT BY THE CONTRACTOR.

TREES DESIGNATED FOR REMOVAL SHALL BE TAGGED BY CONTRACTOR AND APPROVED BY OWNER'S REPRESENTATIVE PRIOR TO COMMENCEMENT OF CONSTRUCTION.

THE STORAGE OF MATERIALS AND EQUIPMENT WILL BE PERMITTED AT LOCATIONS DESIGNATED BY OWNER OR OWNER'S REPRESENTATIVE. PROTECTION OF STORED MATERIALS AND EQUIPMENT SHALL BE THE SOLE RESPONSIBILITY OF THE CONTRACTOR.

STRIP & STORE EXISTING TOPSOIL FOR LATER REUSE WHERE APPROPRIATE, AND AS NOTED ON PLAN, WITH APPROPRIATE EROSION AND SEDIMENT CONTROLS.

LOAM / TOP SOIL DESIGNATED FOR REUSE AS GENERAL FILL SHALL BE BLENDED WITH SUITABLE BORROW MATERIAL AS SPECIFIED.

THE CONTRACTOR SHALL PROTECT EXISTING TREES TO REMAIN. CONTRACTOR SHALL INSTALL TREE PROTECTION BARRIER AFTER CLEARING UNDERBRUSH AND TAKE DUE CARE TO PREVENT INJURY TO TREES DURING CLEARING OPERATIONS.

**LEGEND**

- EXISTING AC TO REMAIN
- EXISTING AC TO BE REMOVED
- EXISTING CONCRETE TO REMAIN
- EXISTING CONCRETE TO BE REMOVED

**DEMOLITION KEY NOTES**

- 1** REMOVE EXISTING FIRE HYDRANT
- 2** REMOVE EXISTING METERS AND BOXES - TIE INTO CUSTOMER SIDE
- 3** SAWCUT AND REMOVE EXISTING AC
- 4** EXISTING WATER SERVICE TO BE ABANDONED IN PLACE
- 5** EXISTING LATERAL TO BE REMOVED AND REPLACED
- 6** REMOVE EXISTING TEE, GATE VALVE, PIPE AND FIRE HYDRANT.

REVISIONS	BY


**EXISTING SITE & DEMOLITION PLAN**




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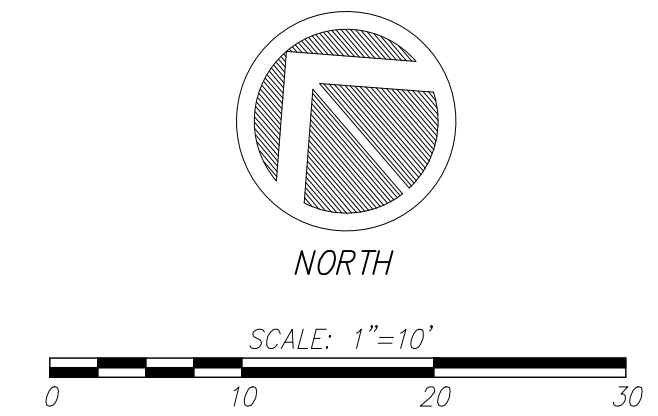
**SCOTTS VALLEY WATER DISTRICT  
 BETHANY DRIVE  
 WATER MAIN IMPROVEMENTS**

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Job:	165.95
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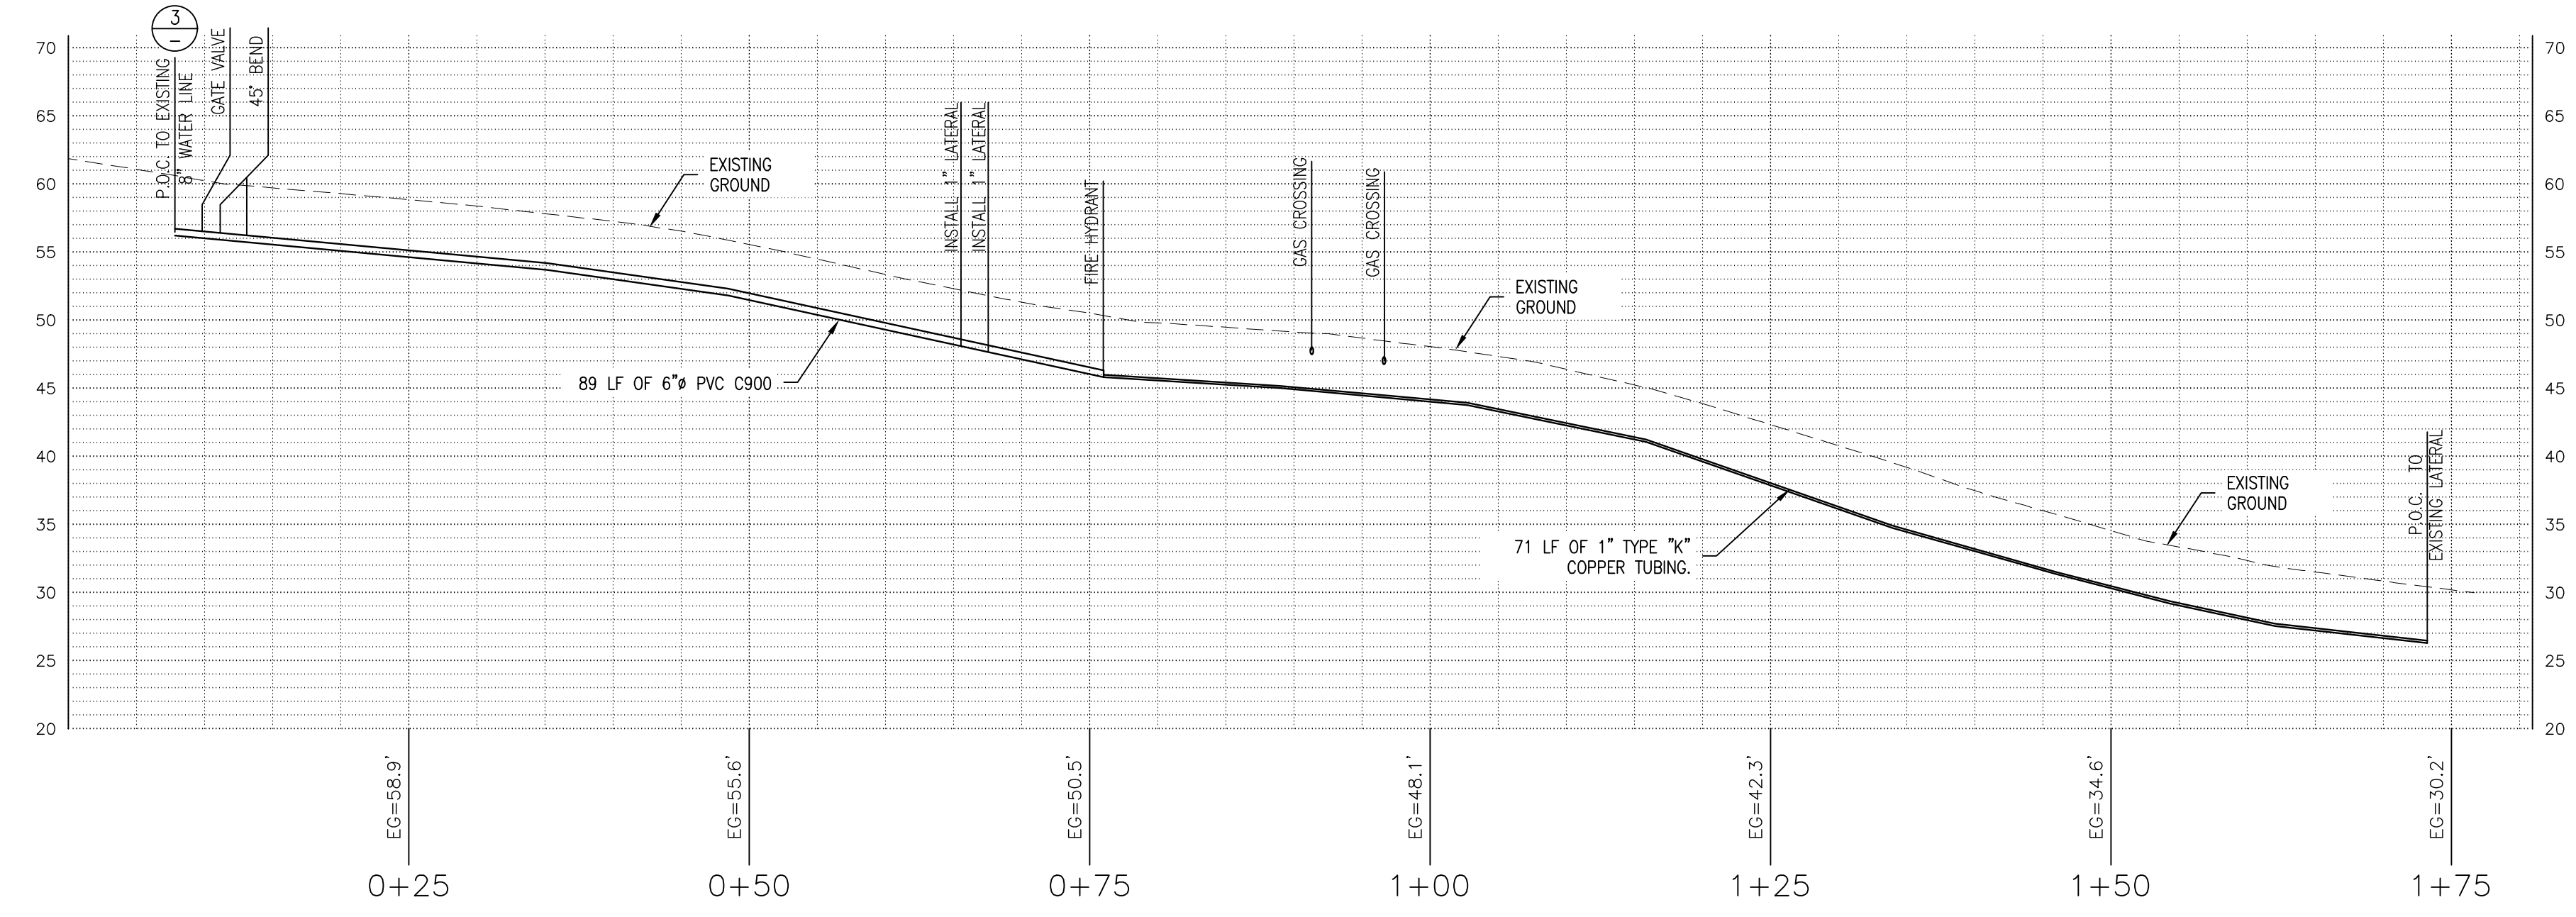


- IMPROVEMENT NOTES:**
- ALL JOINT FITTINGS ARE TO BE MECHANICAL RESTRAINTS
  - TIE-IN OF SYSTEM AND LATERALS TO OCCUR IN ONE DAY BETWEEN 7:00AM - 4:00PM
  - DEPTH OF WATER MAIN WILL VARY BASED ON POTHOLES - STANDARD DEPTH OF 3' TO 3.5' WILL BE MAINTAINED
  - ALL BELLS NEED TO BE RESTRAINED
  - ALL JOINTS INCLUDING MEGA LUGS MUST USE THRUST BLOCKS
  - ALL NON-RESTRAINED FITTINGS MAY REQUIRE ADDITIONAL BLOCKING TO THE THRUST BLOCK IF THERE IS INADEQUATE TIME FOR THE CONCRETE TO SET UP

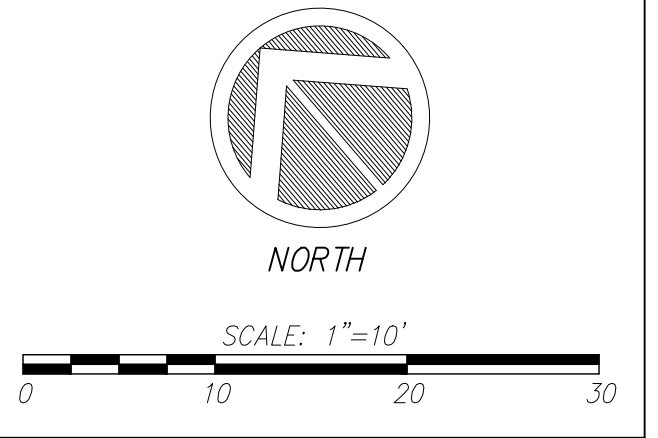

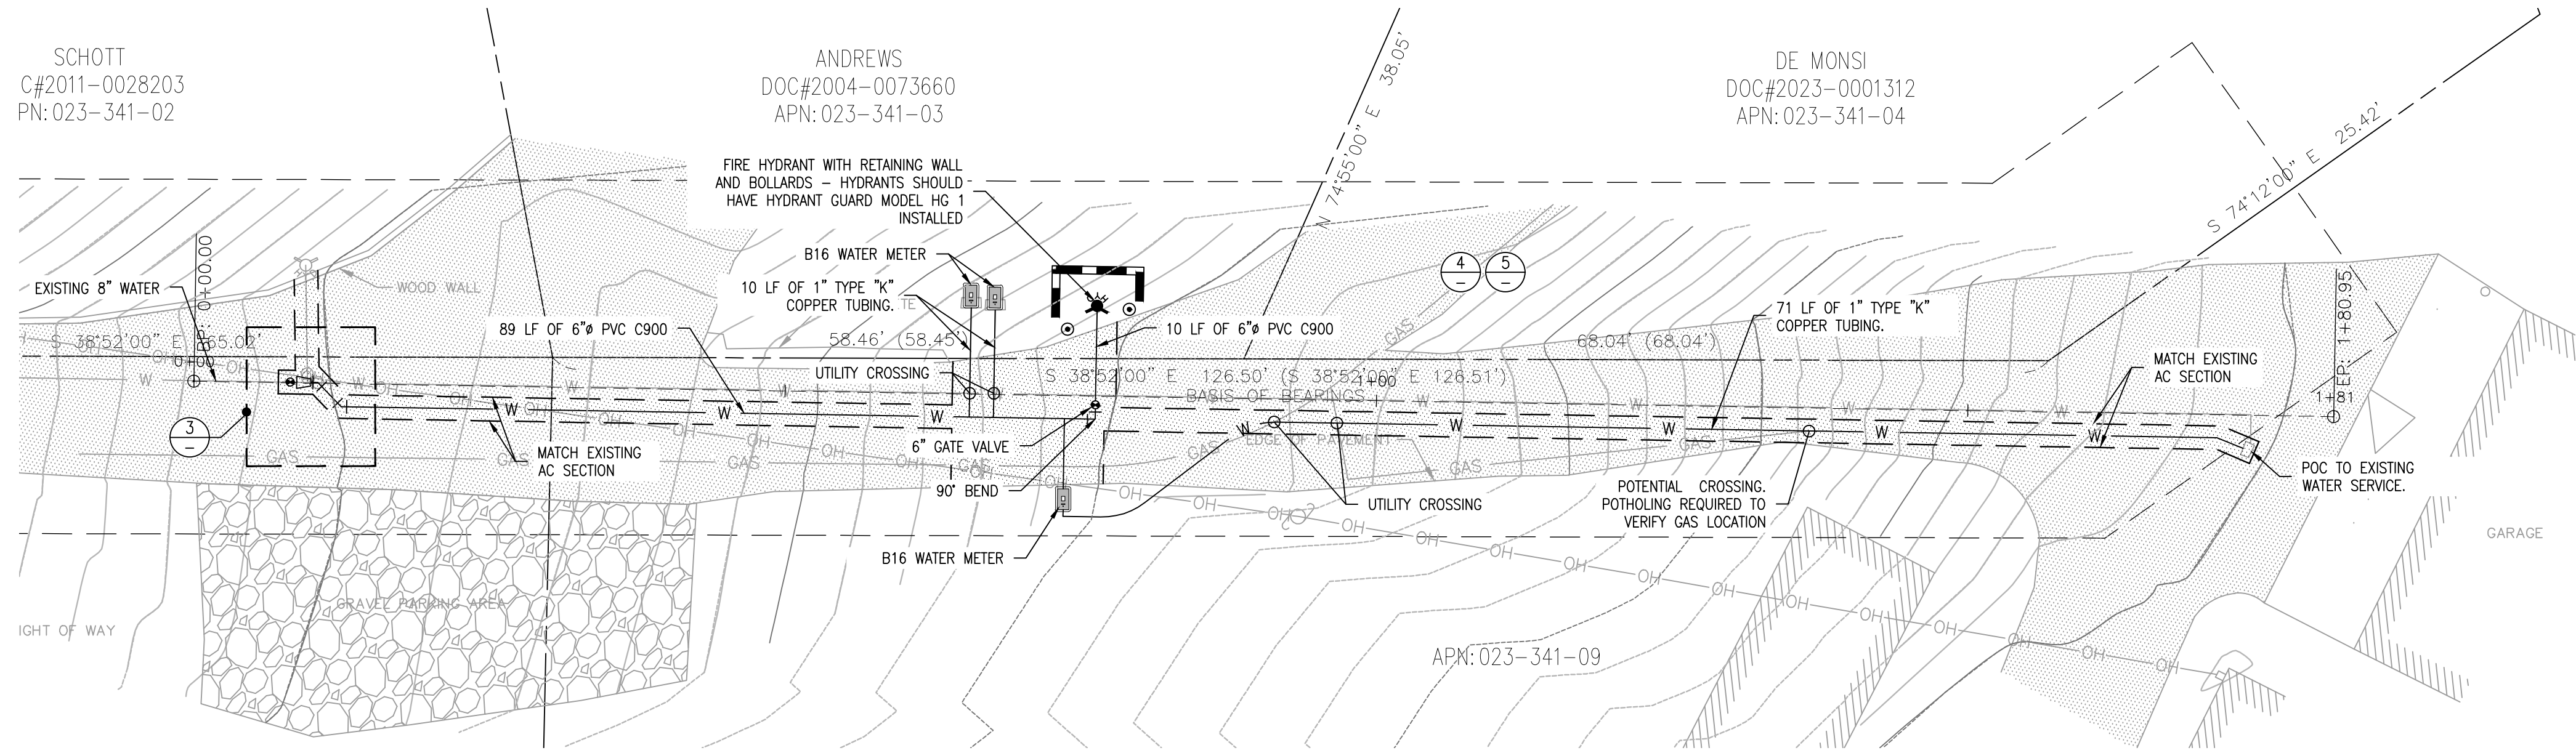
1 BETHANY COURT PLAN VIEW

Scale: 1:1




2 BETHANY COURT PROFILE VIEW

Scale: 1"=10'

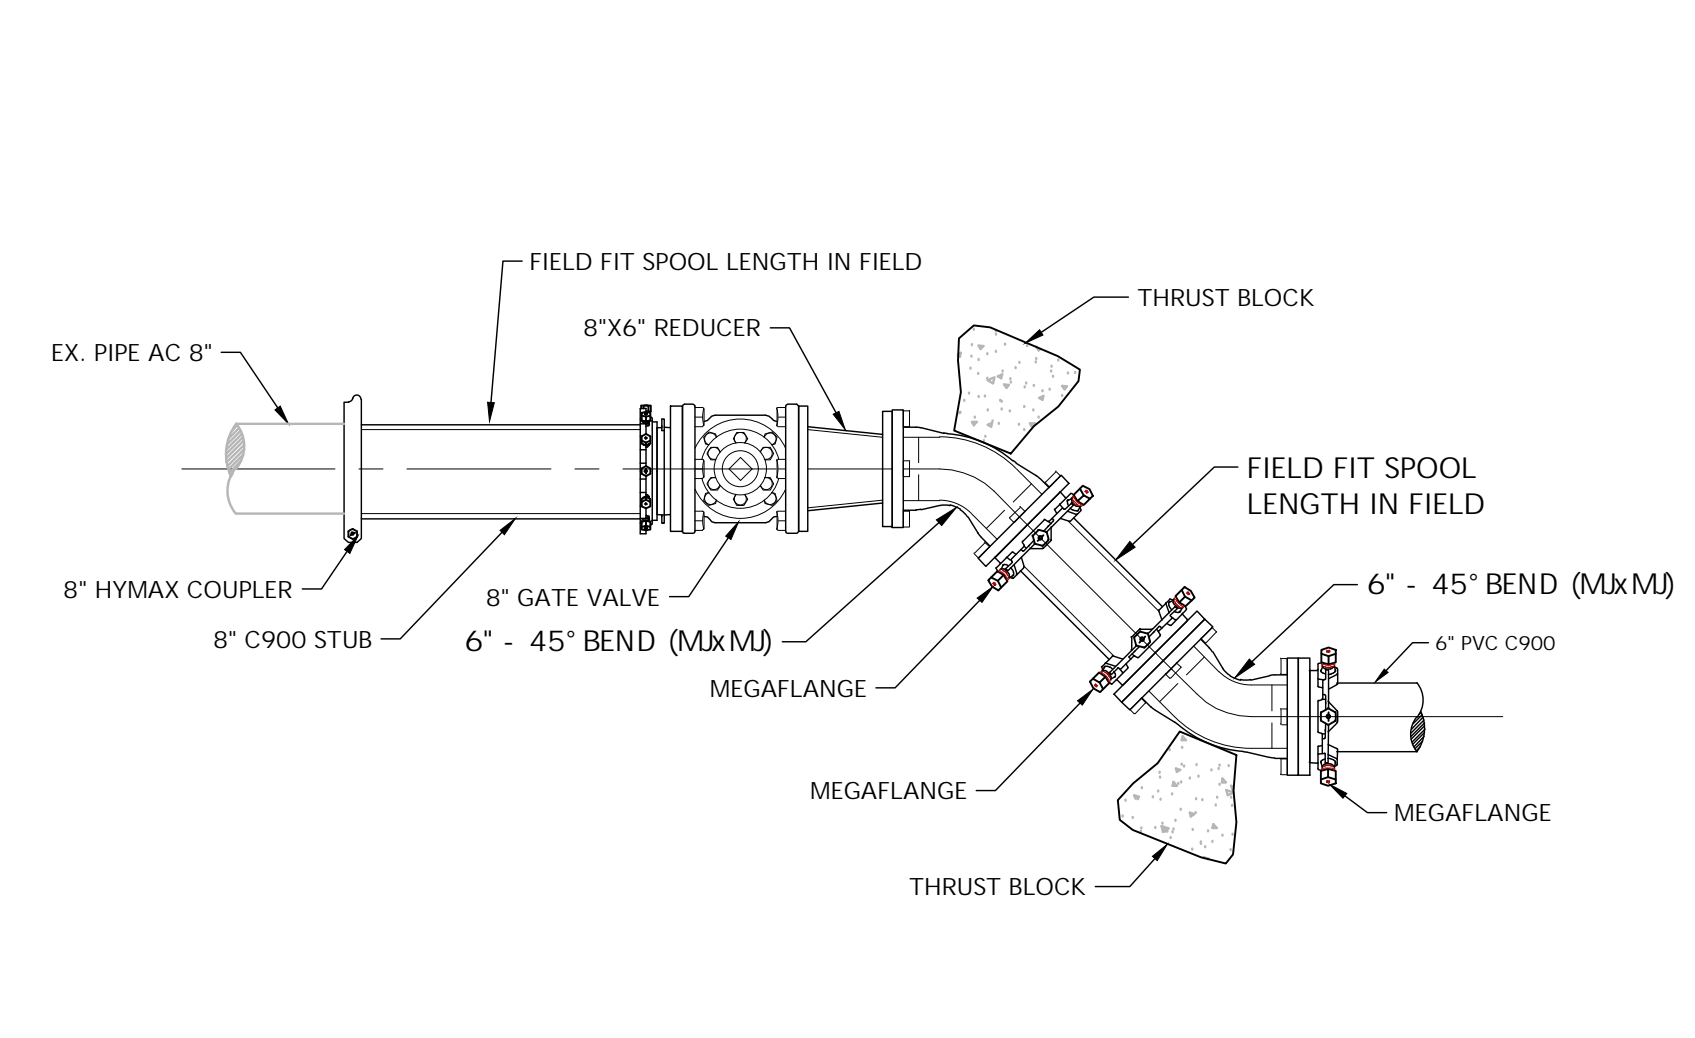

3 P.O.C. MAIN

Scale: NTS

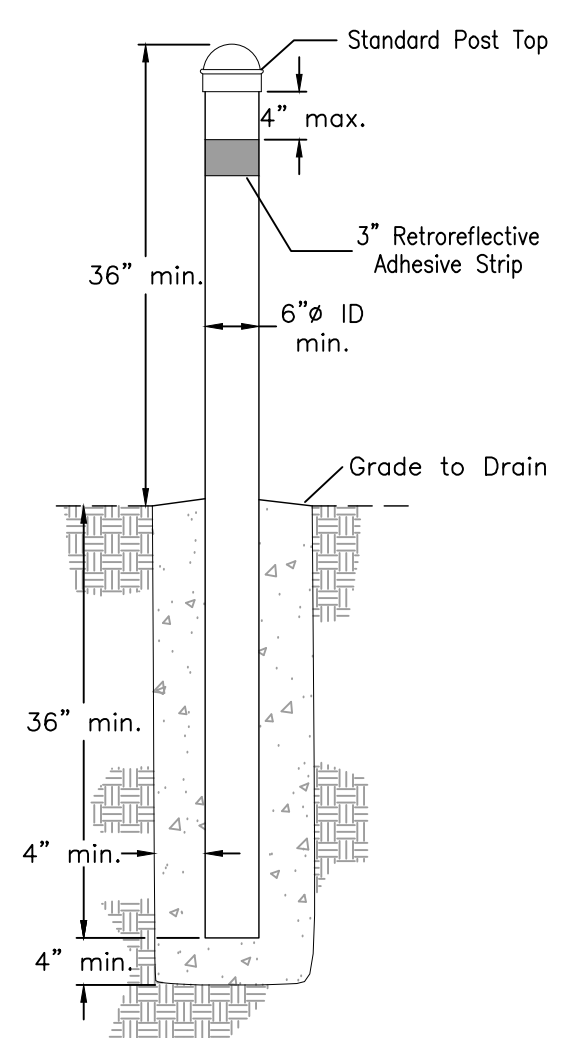

5 FIXED BOLLARD DETAIL


SCALE: NTS

- NOTES:**
- BOLLARD SHALL BE FABRICATED FROM GALVANIZED IRON PIPE (GIP), SCH. 40 STEEL PIPE OR DUCTILE IRON PIPE.
  - BOLLARD SHALL BE A MINIMUM OF 6" INSIDE DIAMETER.
  - BOLLARDS SHALL BE PROVIDED WITH A STANDARD, MALLEABLE IRON POST TOP.
  - BOLLARD SHALL BE SET A MINIMUM OF 36" INTO CONCRETE POST FOOTING.
  - BOLLARD SHALL BE FILLED WITH CONCRETE PRIOR TO INSTALLING POST CAP. REMOVABLE BOLLARDS SHALL NOT BE CONCRETE FILLED.
  - CONCRETE SHALL BE CLASSED AS MINOR CONCRETE IN ACCORDANCE WITH SECTION 90-1.01, "DESCRIPTION" OF THE CALTRANS STANDARD SPECIFICATIONS.
  - BOLLARD SHALL BE PAINTED OSHA SAFETY YELLOW IN ACCORDANCE WITH WYEAST ENGINEERING STANDARD PLAN 2-01, "UTILITY MARKING SYSTEMS".
  - WHERE PROVIDED FOR IN THE CONTRACT DOCUMENTS, THE BOLLARD SHALL BE COATED WITH A REFLECTIVE COATING OTHERWISE CONFORMING WITH SAID STANDARD PLAN 2-01.
  - ALTERNATIVELY, WHERE PROVIDED FOR IN THE CONTRACT DOCUMENTS, A RETROREFLECTIVE STRIPE SHALL BE PLACED AROUND THE BOLLARD WITHIN 4-INCHES OF THE CAP OF THE COLOR PROVIDED FOR.

RETAINING WALL SCHEDULE			
WALL HEIGHT	2'-0"	3'-0"	4'-0"
POST SPACING	8'-0"	8'-0"	8'-0"
CONCRETE DEPTH	2'-0"	3'-0"	4'-0"
POST LENGTH, MIN.	4'-0"	6'-0"	8'-0"

**RETAINING WALL GENERAL NOTES**

- MAX WALL HEIGHT USING THIS DETAIL TO BE 4.0'
- POSTS AND PLANKS TO BE PRESSURE TREATED (PT).
- CONCRETE: 3000 PSI 28-DAY COMPRESSIVE STRENGTH
- PERMEABLE FILL SHALL MEET THE STATE OF CALIFORNIA STANDARD SPECIFICATION SECTION 68-1.025, CLASS 1, TYPE A. AS AN ALTERNATE 3/4" DOWN OPEN GRADED GRAVEL MAY BE USED.

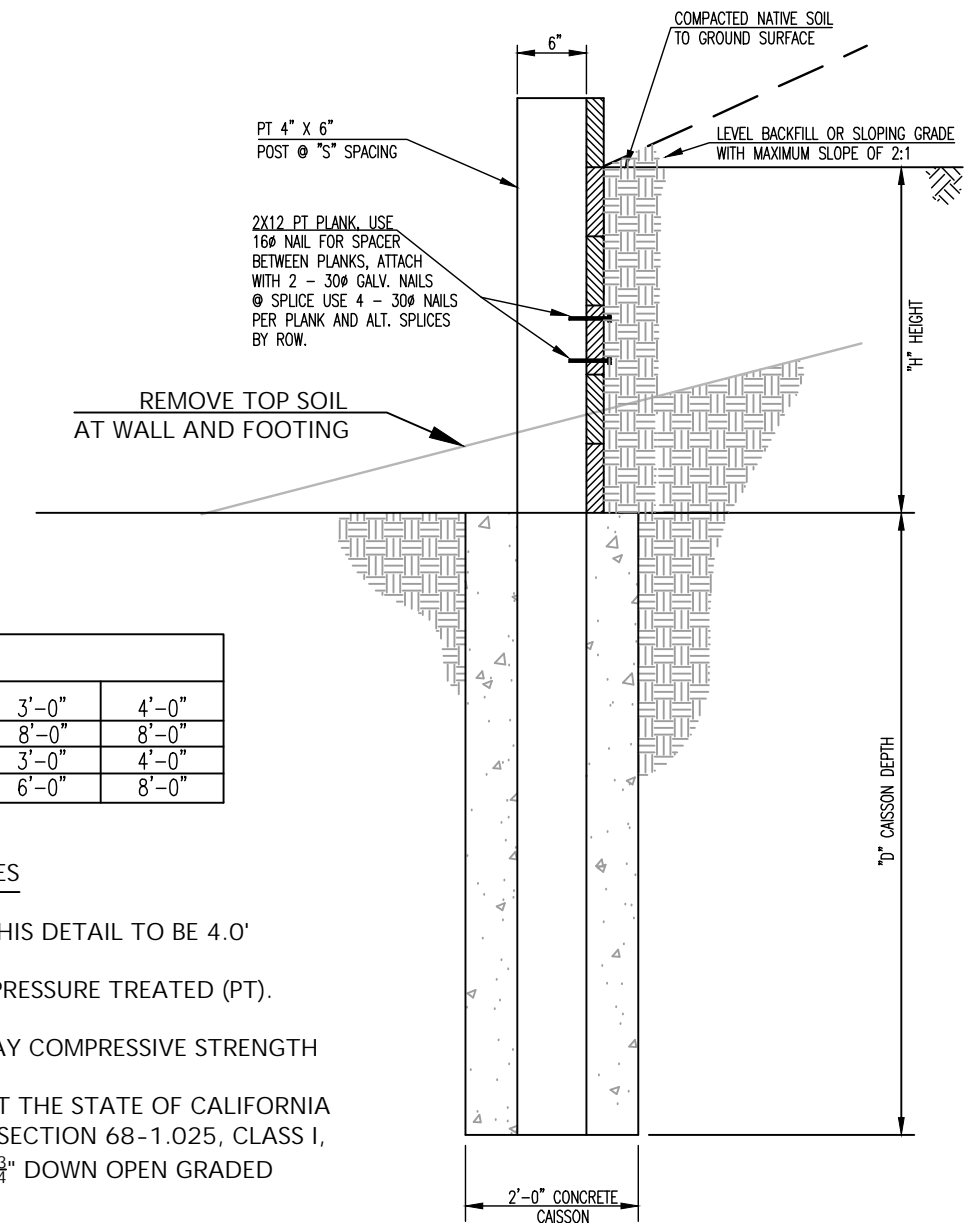

4 WOOD RETAINING WALL

Scale: NTS

REVISIONS	BY

**SITE IMPROVEMENT & UTILITY PLAN**




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 4444 Scotts Valley Drive / Suite 6  
 Scotts Valley, CA 95066  
 831-438-4420

**SCOTS VALLEY WATER DISTRICT  
 BETHANY DRIVE  
 WATER MAIN IMPROVEMENTS**

Date: 09.29.2023  
 Scale: 1" = 10'  
 Drawn: JB/IH/TC  
 Job: 165.95  
 Sheet:  
**C2.1**  
 Of 3 Sheets




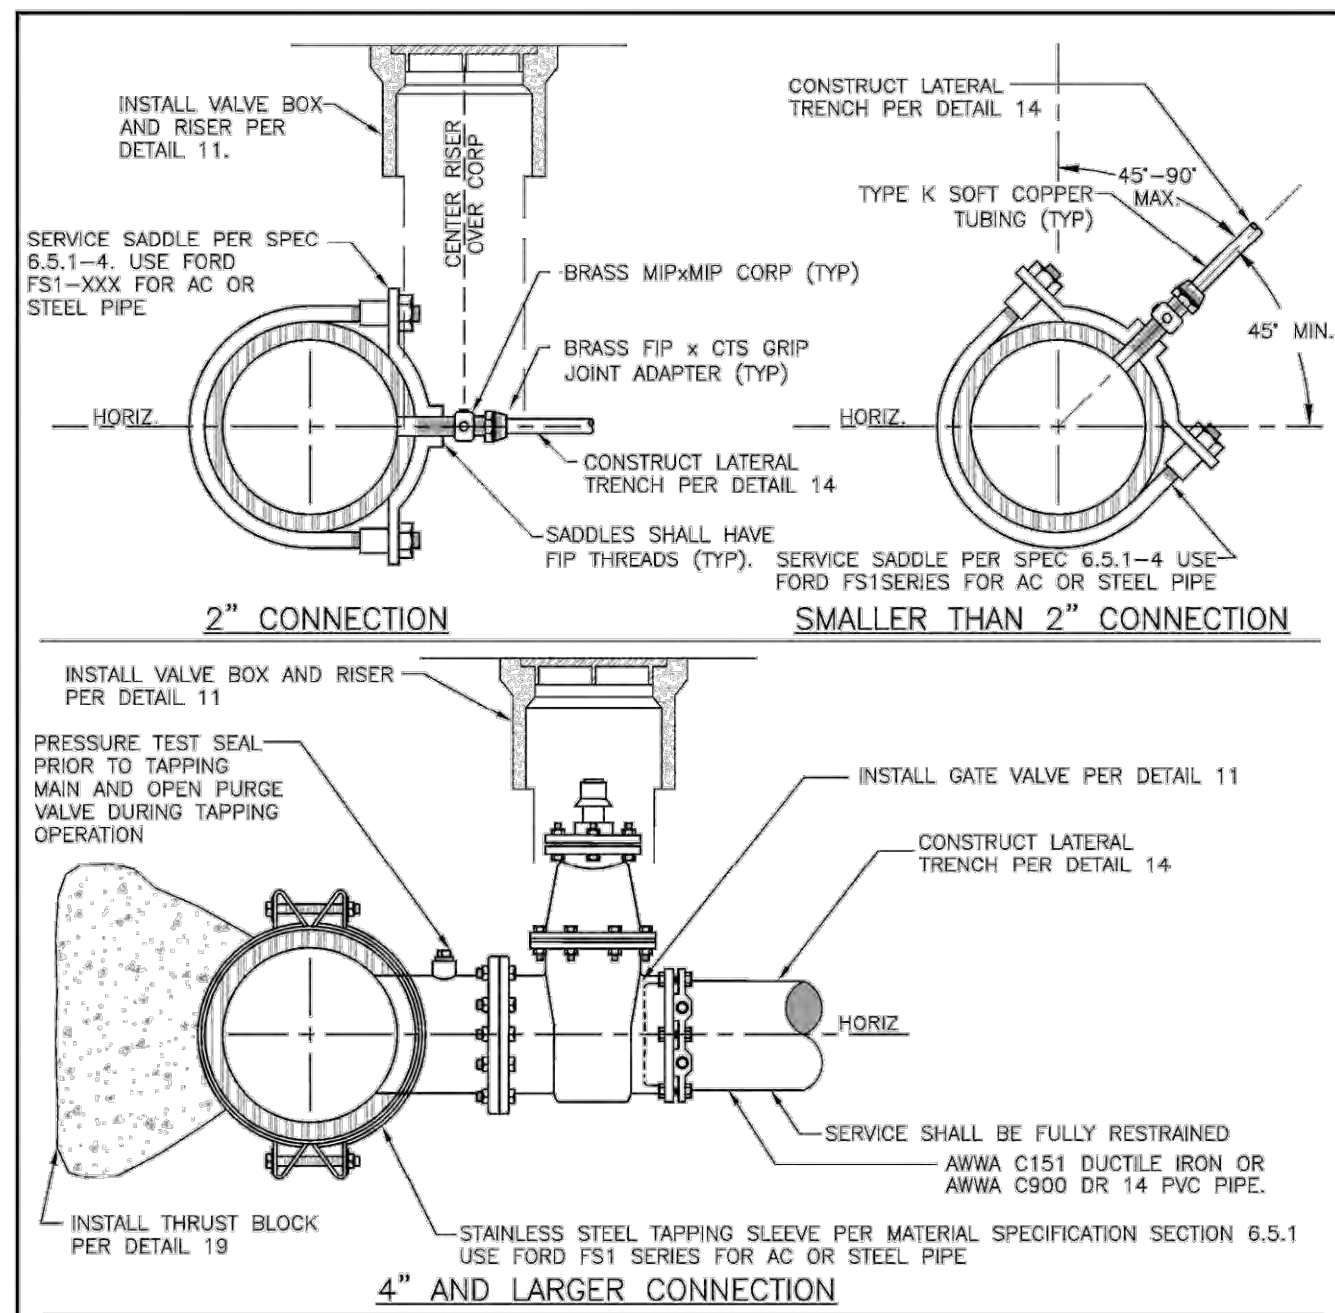

**NOTES**

1. ALL HOT TAP CONNECTIONS SHALL BE MADE IN THE PRESENCE OF THE ENGINEER.
2. ALL HOT TAP CONNECTIONS SHALL BE AT LEAST 24" AWAY FROM ANY JOINT OR FITTING AND 18" AWAY FROM ANY OTHER TAP.
3. CONTRACTOR SHALL OPEN PURGE VALVE DURING TAPPING OPERATION.
4. SERVICE PIPING AND FITTING DIAMETERS SHALL MEET OR EXCEED THE SERVICE SIZE DESIGNATED BY THE ENGINEER.
5. TAPPING BIT SHALL BE OF THE HOLE-SAW OR SHELL TYPE. COUPON OR "COOKIE" SHALL BE SUBMITTED TO THE ENGINEER UPON REQUEST.
6. IF COUPON IS LOST, CONTRACTOR SHALL FULLY OPEN SERVICE IN THE PRESENCE OF THE ENGINEER TO VERIFY FLOW.
7. CONTRACTOR SHALL COAT TAPPING SADDLE, ALL FASTENERS AND SERVICE LINE WITH BITUMASTIC AND/OR ENCASE IN POLYETHYLENE IF DIRECTED BY THE ENGINEER.
8. CONNECTIONS TO MAINS SMALLER THAN 4" SHALL BE SPECIFIED ON A CASE BY CASE BASIS.
9. SERVICE SHALL BE DISINFECTED IF REQUIRED BY THE ENGINEER.


SCOTT'S VALLEY WATER DISTRICT  
WWW.SVWD.ORG  
**DETAIL 1**  
SERVICE CONNECTION  
NOT TO SCALE

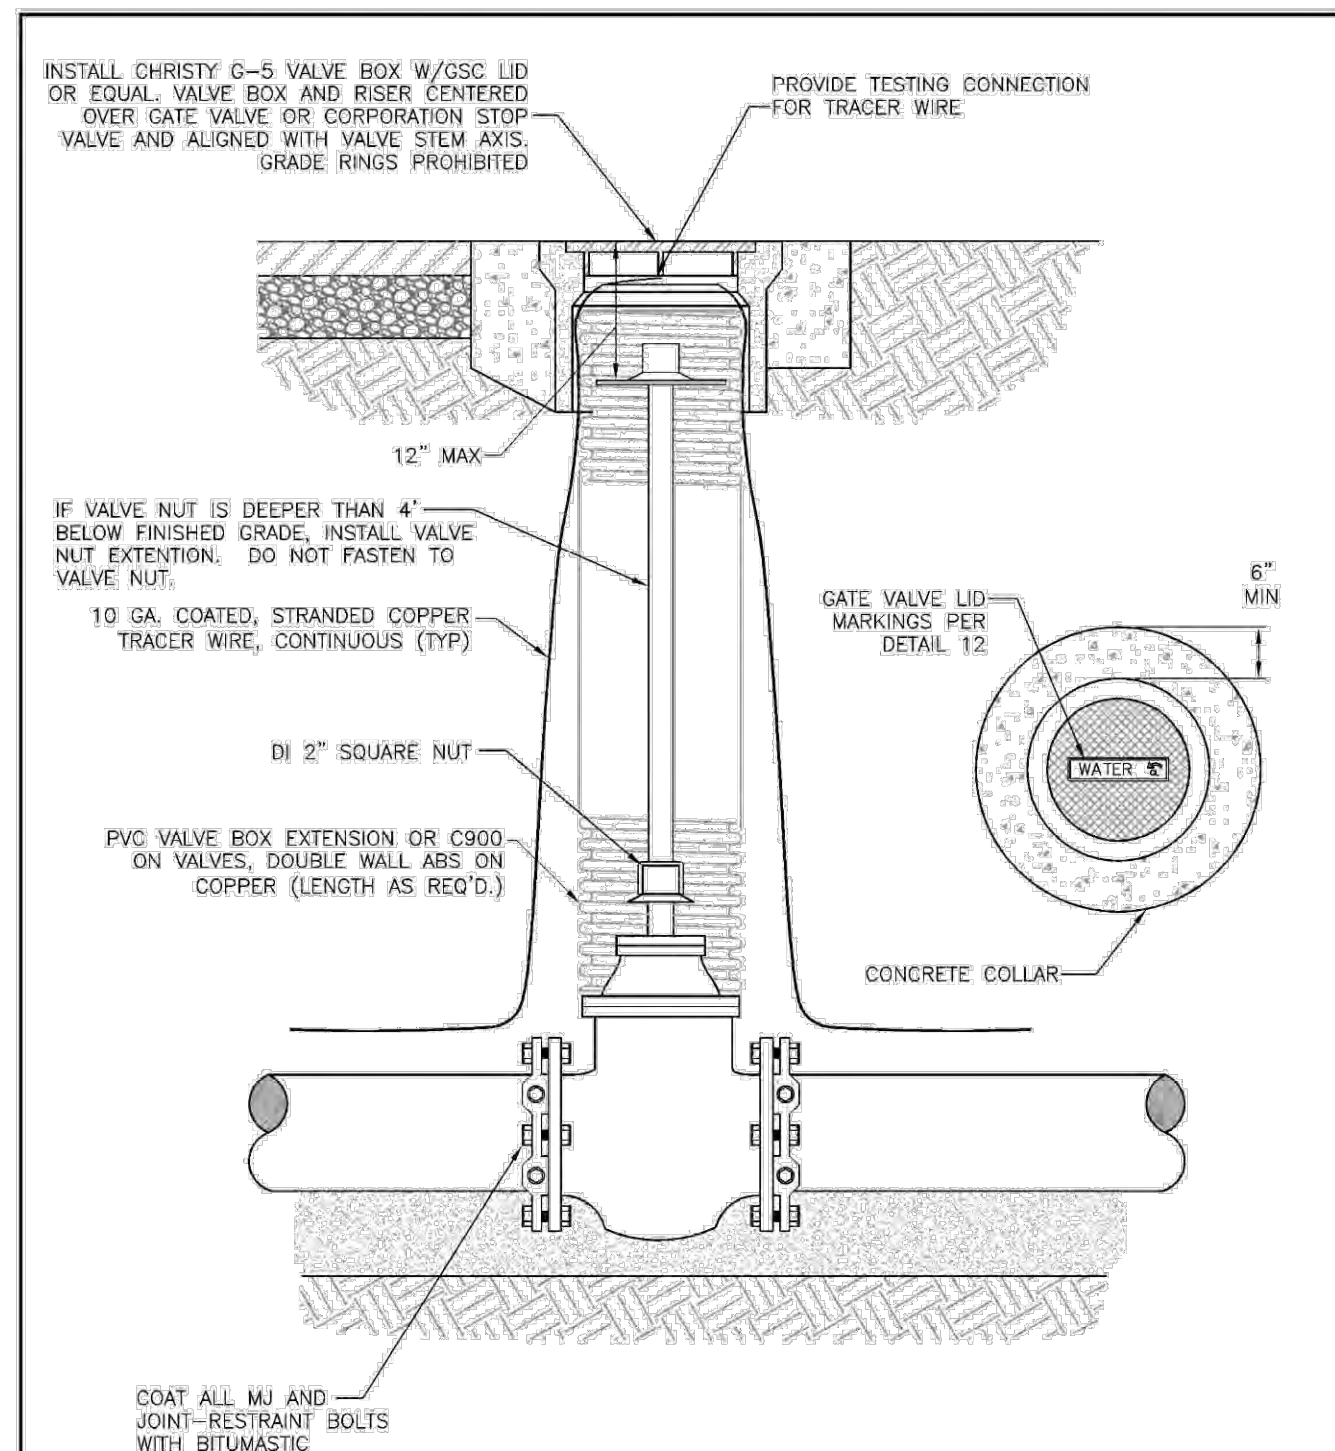

**NOTES**

1. INSTALL BLOCKING UNDER VALVE IF REQUIRED.
2. RISER TERMINATION FOR GATE VALVE SHALL OCCUR AT VALVE FLANGE.
3. RISER TERMINATION FOR SERVICE CONNECTION (2" & SMALLER) SHALL OCCUR 1" BELOW CORP STOP.
4. VALVE BOX LID SHALL BE OILED PRIOR TO PAVING OR CLEANING TO ENSURE THAT LID MARKINGS ARE LEGIBLE.
5. INSTALL VALVE BOX LID FLUSH WITH FINAL PAVING OR GROUND SURFACE.


SCOTT'S VALLEY WATER DISTRICT  
WWW.SVWD.ORG  
**DETAIL 11**  
GATE VALVE INSTALLATION  
NOT TO SCALE

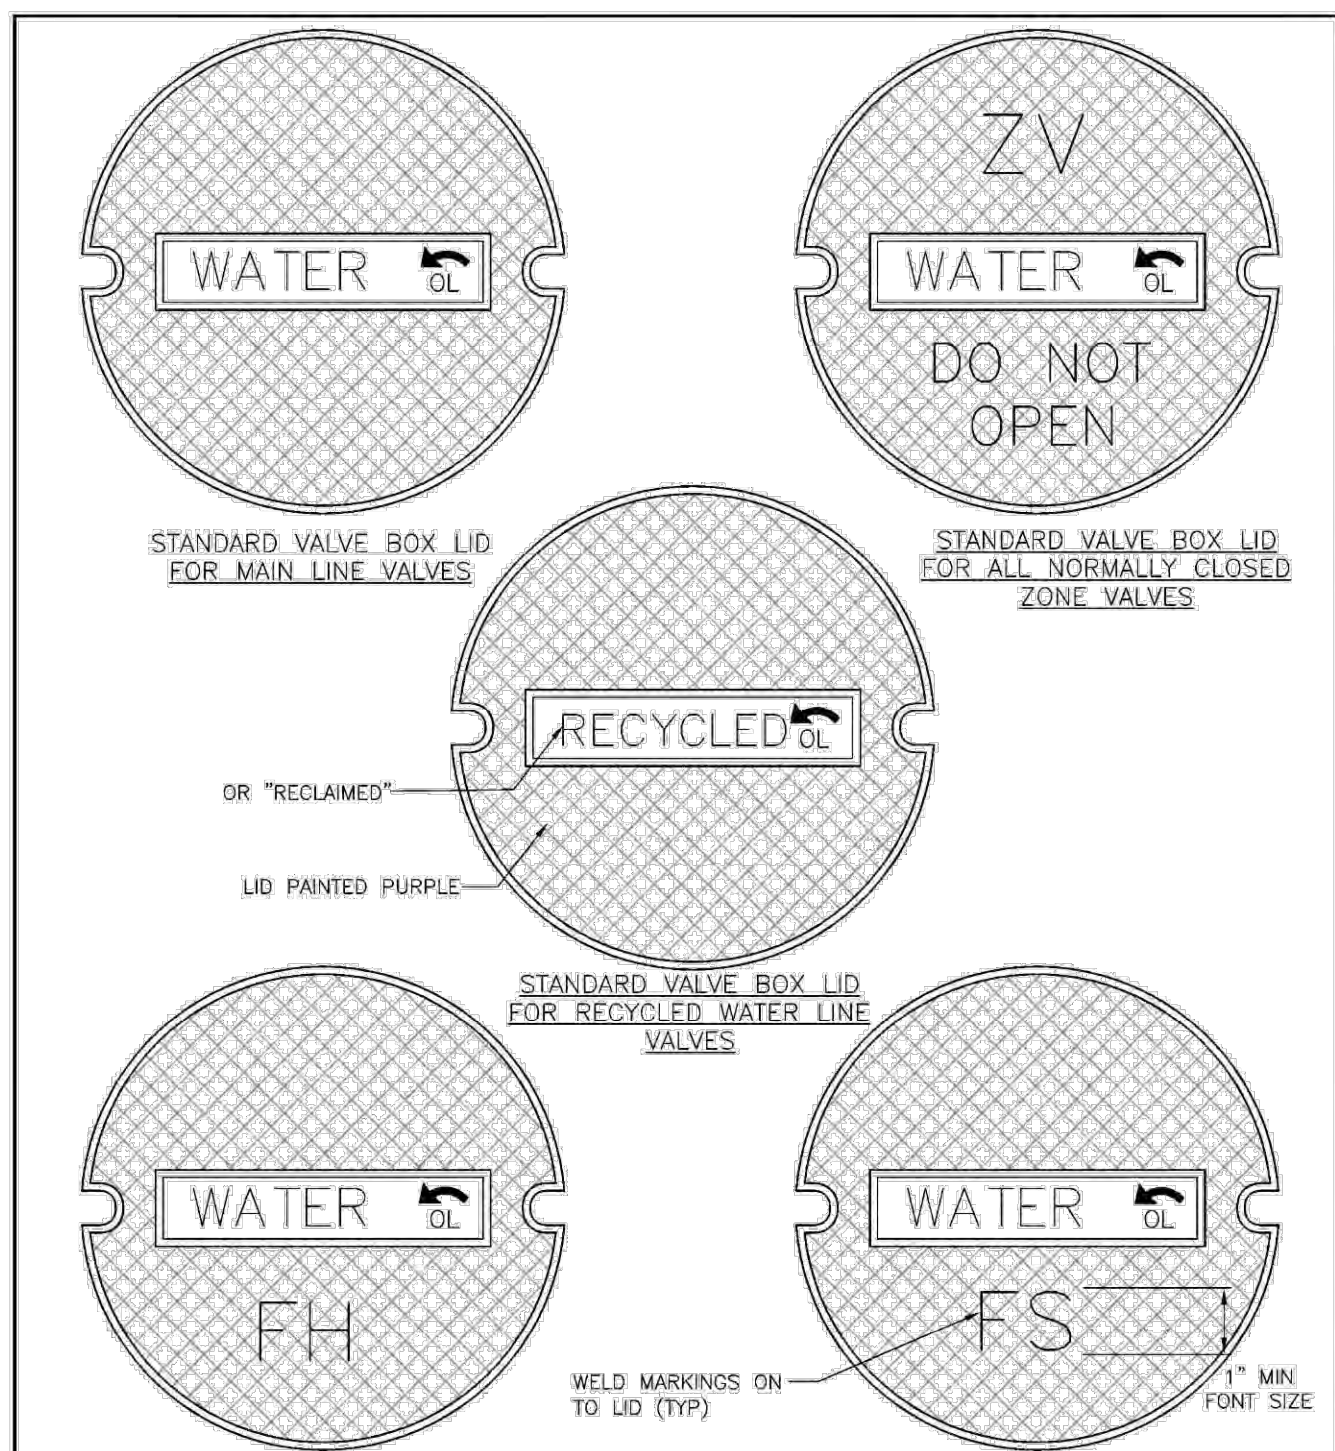

**NOTES**

1. BUTTERFLY VALVE BLOW OFF VALVE TEST STATION ZONE VALVE FIRE SERVICE FIRE HYDRANT RAW WATER RECYCLED WATER
2. BFB BO TS ZV FS FH RW REC
3. BLUE BLUE BLUE BLUE BLUE YELLOW TAN PURPLE
4. LID PAINTED PURPLE
5. WELD MARKINGS ON TO LID (TYP)
6. 1" MIN. FONT SIZE


SCOTT'S VALLEY WATER DISTRICT  
WWW.SVWD.ORG  
**DETAIL 12**  
VALVE BOX LID MARKINGS  
NOT TO SCALE

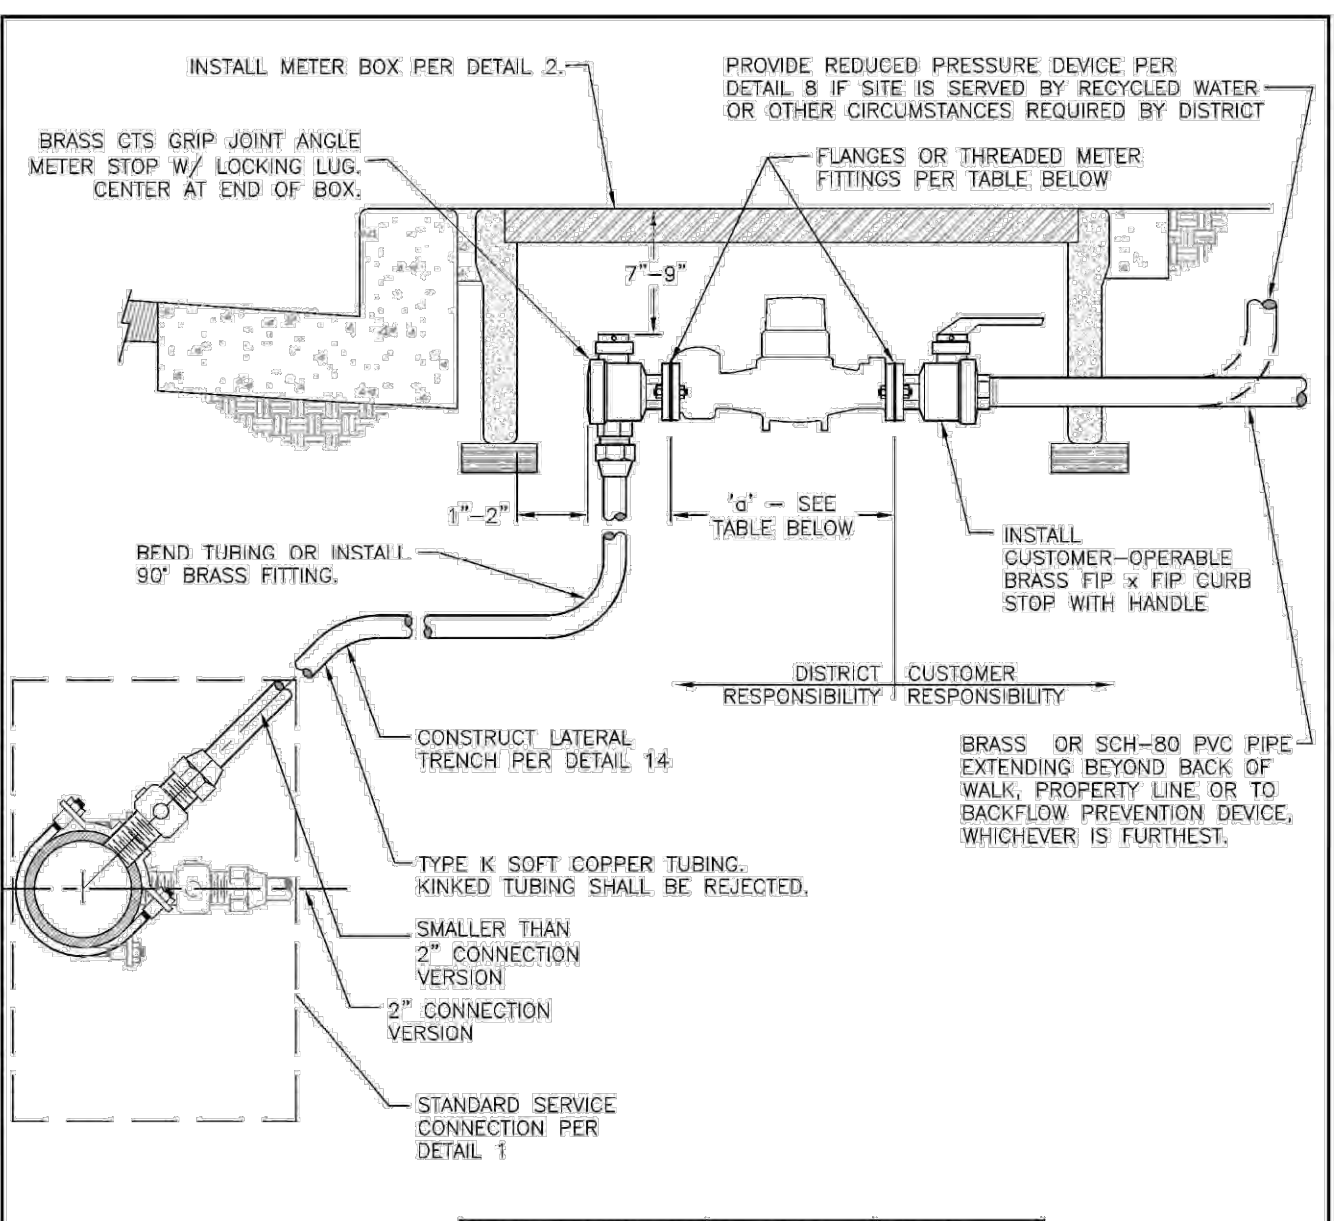

**NOTES**

1. BRASS FITTINGS, VALVES AND PIPE SHALL CONSIST OF LOW-LEAD BRASS ALLOY AND SHALL HAVE A MINIMUM WORKING PRESSURE OF 150 PSI.
2. METERS WILL BE FURNISHED AND INSTALLED BY DISTRICT.
3. A BACKFLOW PREVENTION ASSEMBLY SHALL BE INSTALLED PER DETAIL 8 IF REQUIRED BY THE ENGINEER.


SCOTT'S VALLEY WATER DISTRICT  
WWW.SVWD.ORG  
**DETAIL 5**  
2-INCH AND SMALLER SERVICE INSTALLATION  
NOT TO SCALE

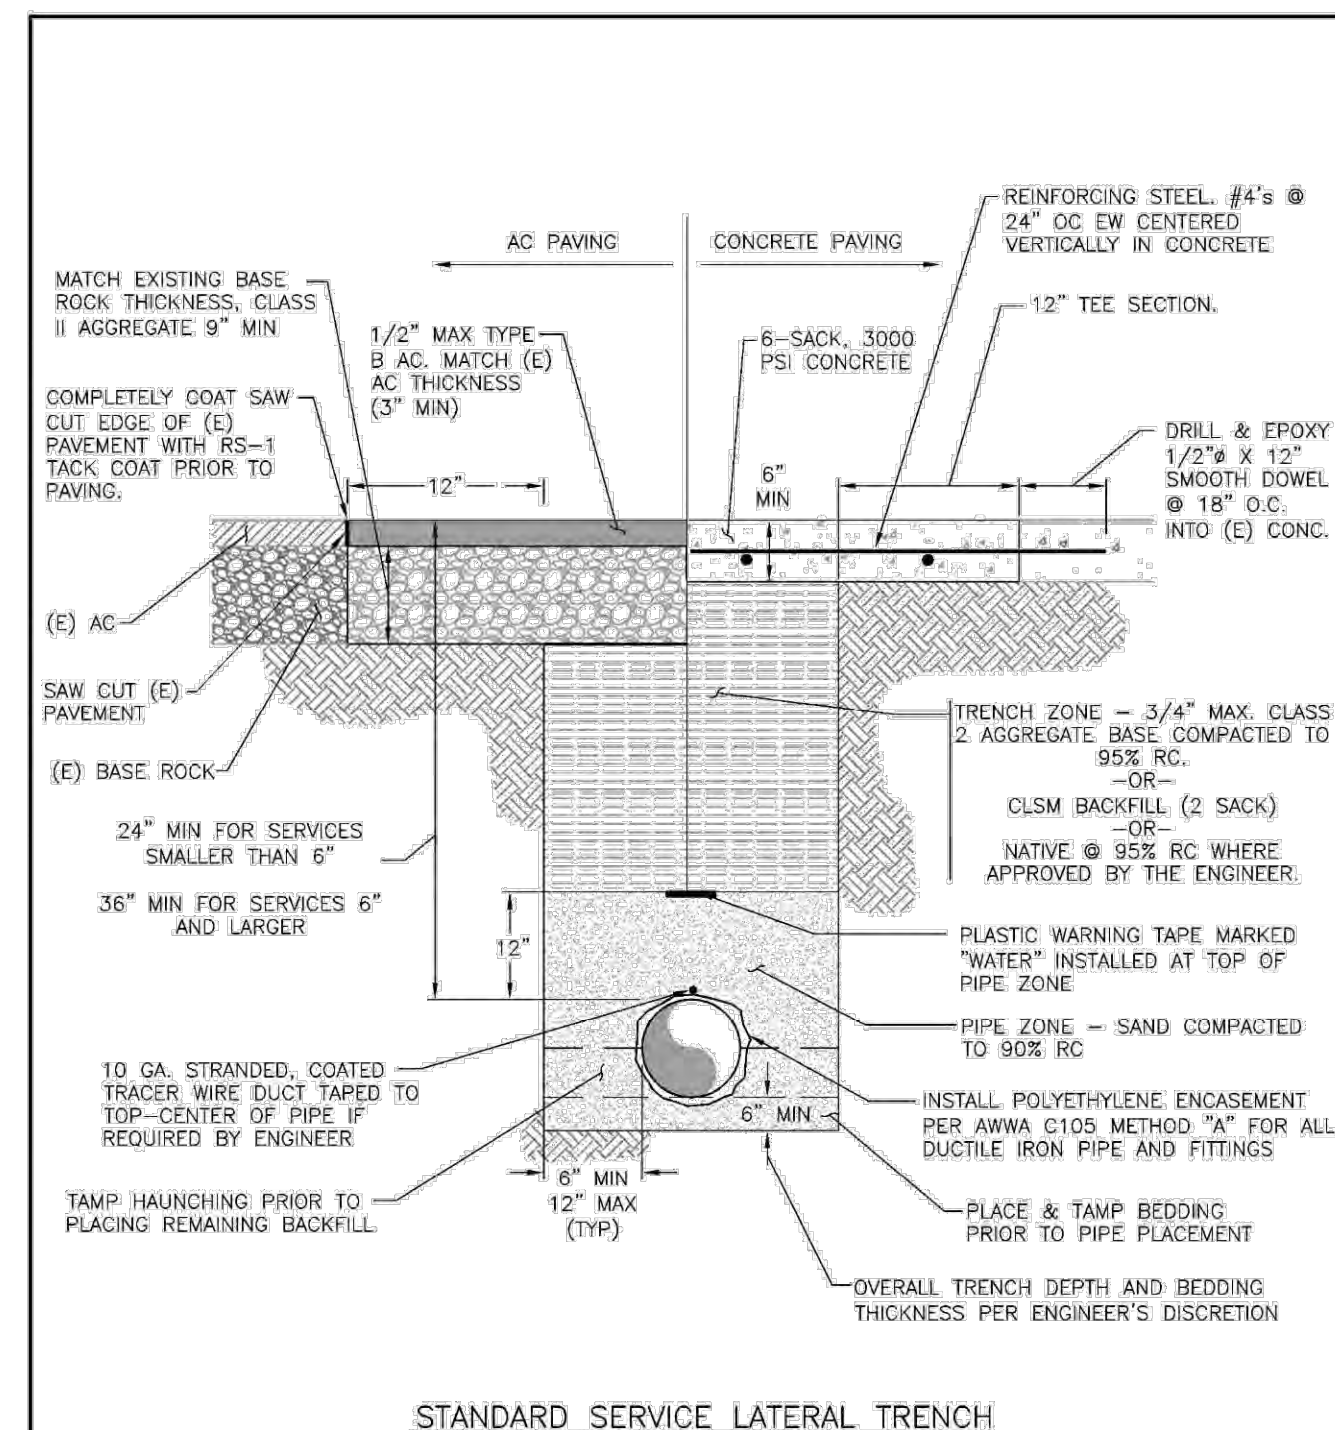

**NOTES**

1. IF ANY PORTION OF (E) PAVEMENT WITHIN SAWCUT LIMITS IS CONCRETE AT THE SURFACE, ENTIRE TRENCH SHALL BE RE-PAVED WITH CONCRETE AS SHOWN.
2. WHERE WATER SERVICES 6" AND LARGER CANNOT MEET MINIMUM COVER REQUIREMENTS, THE ENGINEER MAY APPROVE ALTERNATE INSTALLATION PER DETAIL 16.
3. ALL JOINTS ON SERVICE LATERALS SHALL BE RESTRAINED.


SCOTT'S VALLEY WATER DISTRICT  
WWW.SVWD.ORG  
**DETAIL 14**  
STANDARD SERVICE LATERAL TRENCH  
NOT TO SCALE

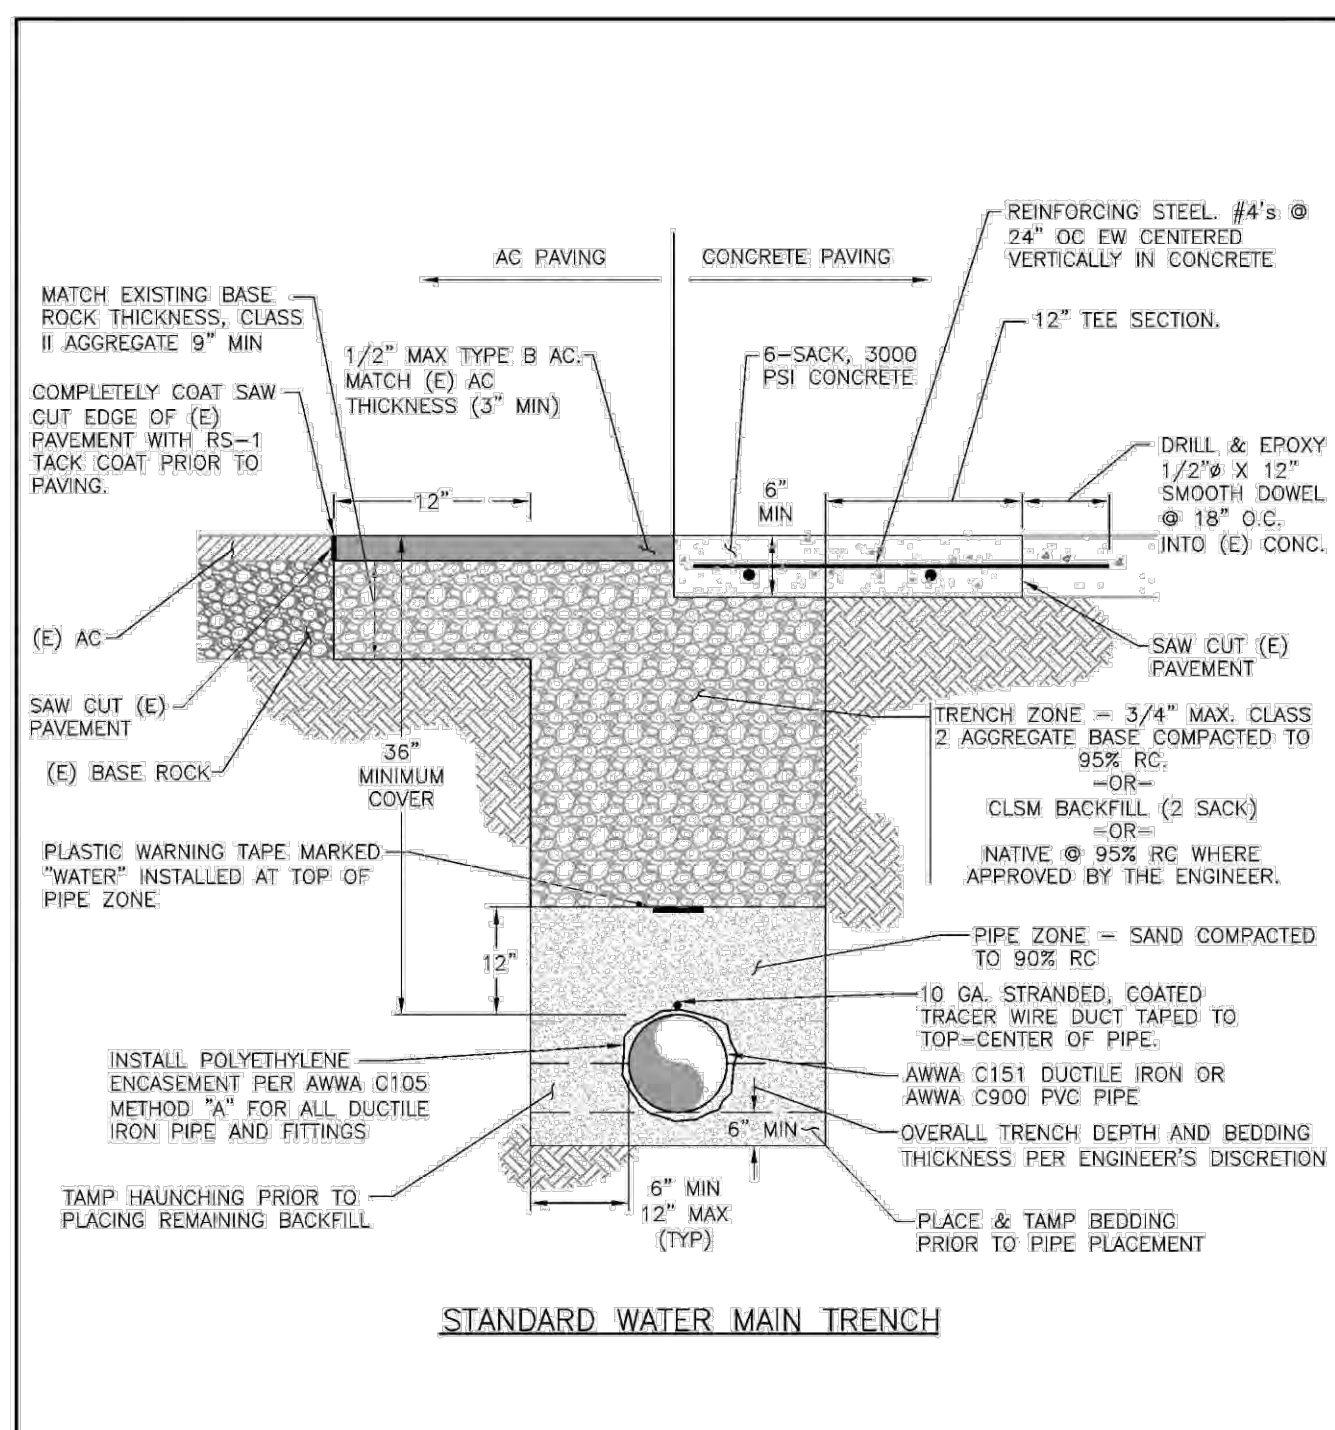

**NOTES**

1. IF ANY PORTION OF (E) PAVEMENT WITHIN SAWCUT LIMITS IS CONCRETE AT THE SURFACE, ENTIRE TRENCH SHALL BE RE-PAVED WITH CONCRETE AS SHOWN.
2. WHERE WATER MAIN INSTALLATION CANNOT MEET MINIMUM COVER REQUIREMENTS, THE ENGINEER MAY APPROVE ALTERNATE INSTALLATION PER DETAIL 16.
3. REFER TO SVWD TECHNICAL SPECIFICATIONS FOR COMPACTION TESTING REQUIREMENTS.
4. FOR SERVICE LATERALS, REFER TO DETAIL 14.


SCOTT'S VALLEY WATER DISTRICT  
WWW.SVWD.ORG  
**DETAIL 15**  
STANDARD WATER MAIN TRENCH  
NOT TO SCALE

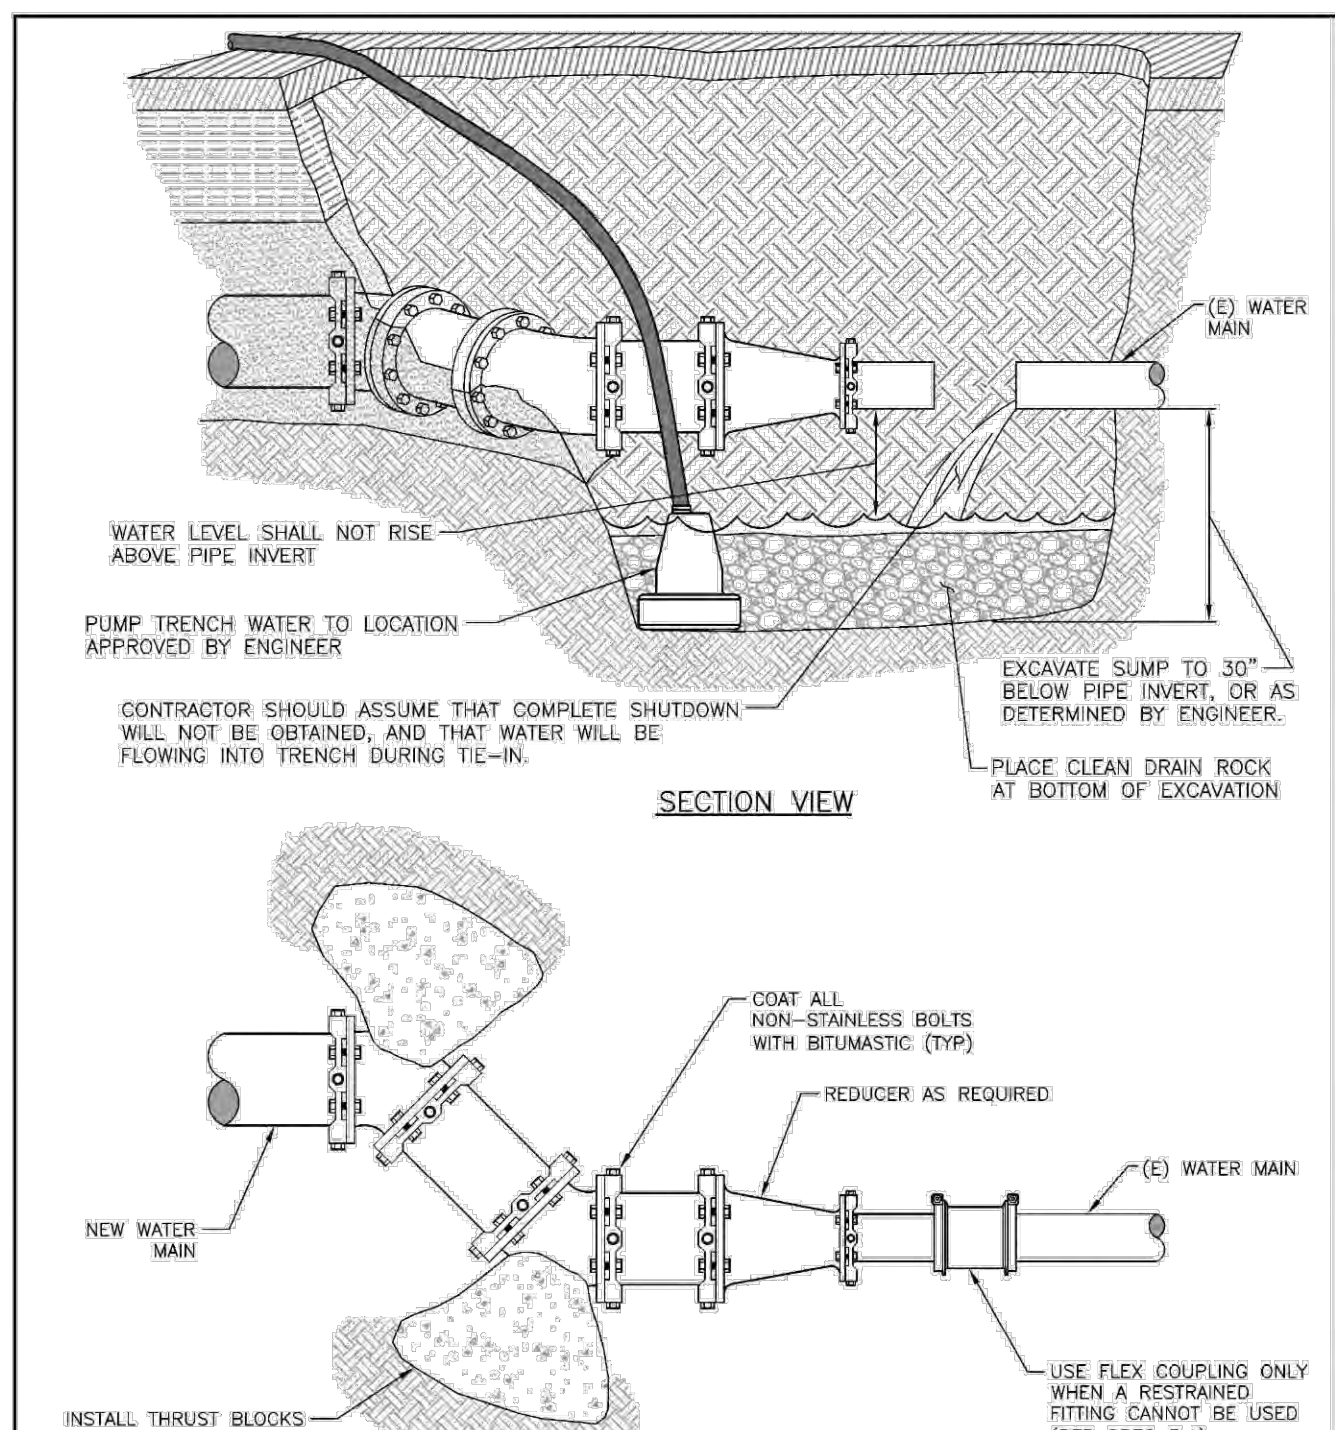

**NOTES**

1. CONTRACTOR SHALL VERIFY (E) MAIN DIAMETER PRIOR TO SCHEDULING SYSTEM SHUT DOWN.
2. ELBOWS SHARPER THAN 45° ARE NOT ALLOWED.
3. PIPE AND FITTING SIZES & MATERIAL SHALL BE SPECIFIED BY ENGINEER.
4. JOINT RESTRAINTS AND THRUST BLOCKING PER DETAILS 19 AND 20 ARE REQUIRED.
5. TEMPORARY THRUST BLOCKING MAY BE REQUIRED WHILE CONCRETE CURES.

SCOTT'S VALLEY WATER DISTRICT  
WWW.SVWD.ORG  
**DETAIL 17**  
SYSTEM CONNECTION (TIE IN)  
NOT TO SCALE

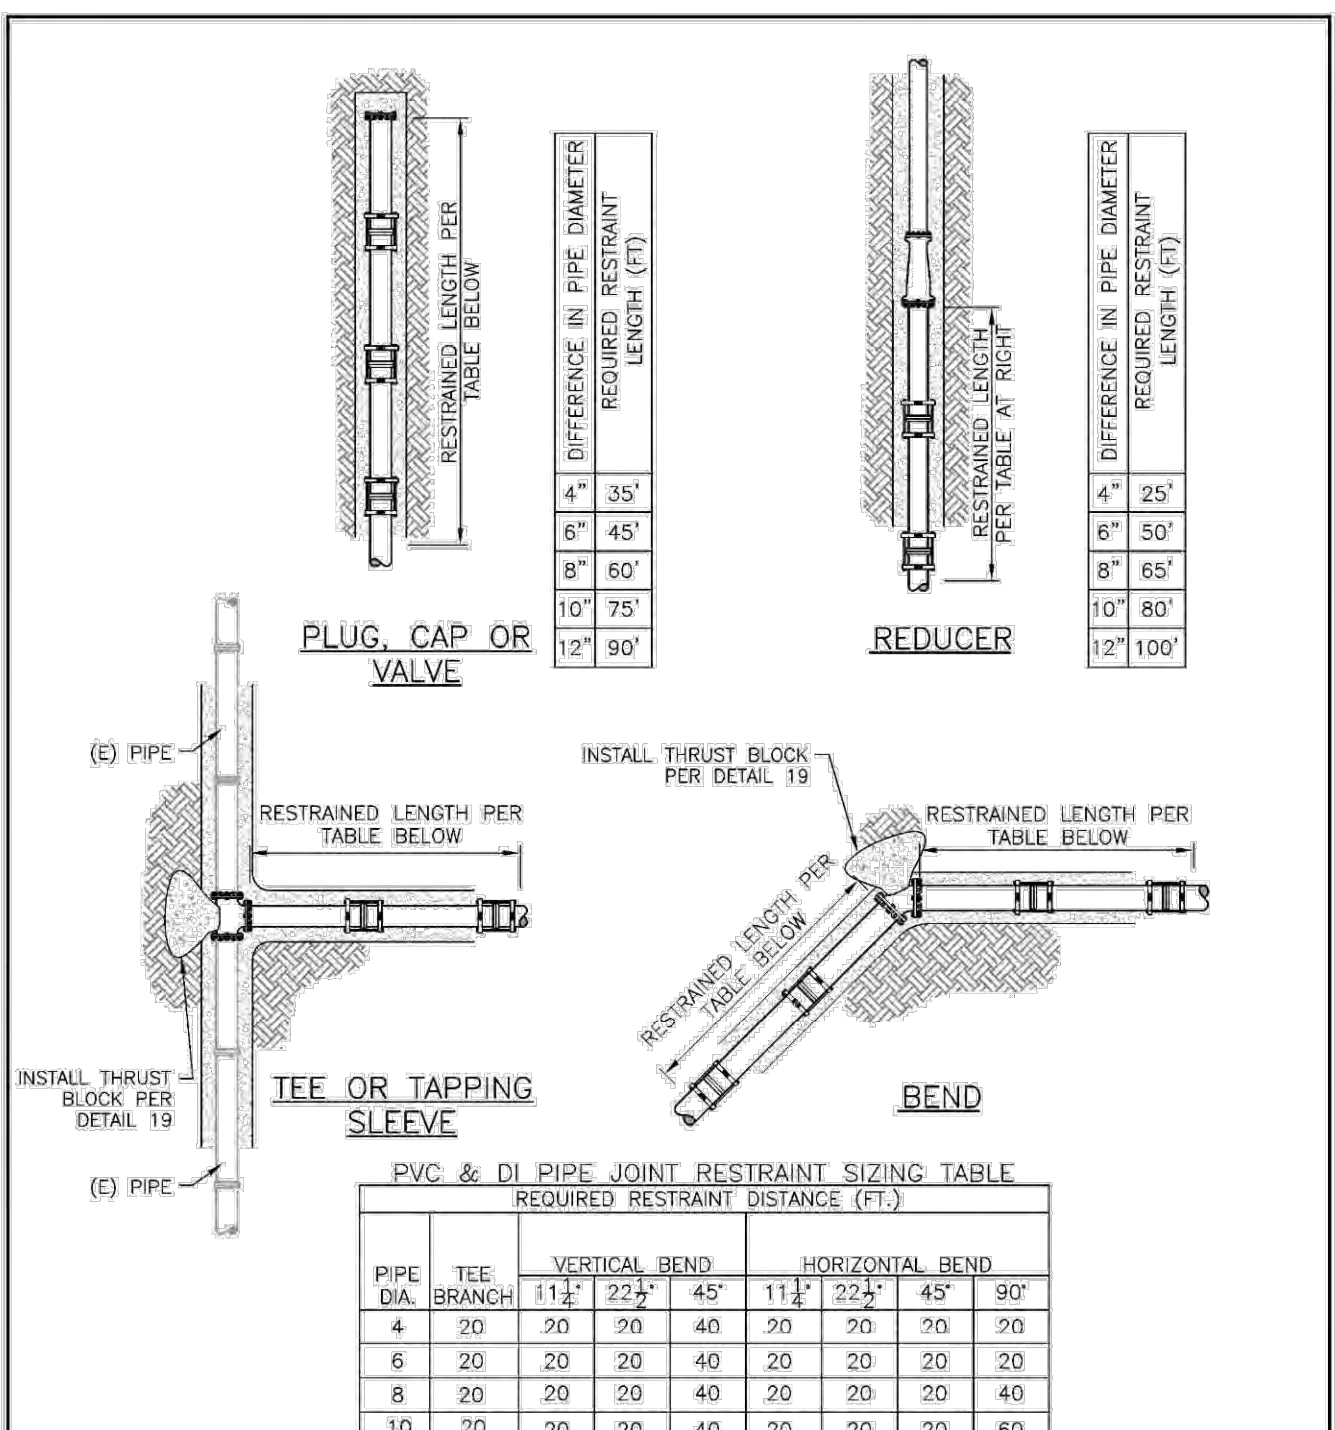

**NOTES**

1. ALL UNCOATED JOINT RESTRAINT AND FITTING HARDWARE SHALL BE COATED WITH BITUMASTIC.
2. THRUST BLOCKING PER DETAIL 19 IS REQUIRED.
3. SERVICE LATERALS SHALL BE FULLY RESTRAINED.

SCOTT'S VALLEY WATER DISTRICT  
WWW.SVWD.ORG  
**DETAIL 18**  
JOINT RESTRAINT INSTALLATION  
NOT TO SCALE

REVISIONS	BY

**DETAILS**



SCOTT'S VALLEY WATER DISTRICT  
WWW.SVWD.ORG  
**DETAIL 1**  
SERVICE CONNECTION  
NOT TO SCALE

SCOTT'S VALLEY WATER DISTRICT  
WWW.SVWD.ORG  
**DETAIL 11**  
GATE VALVE INSTALLATION  
NOT TO SCALE

SCOTT'S VALLEY WATER DISTRICT  
WWW.SVWD.ORG  
**DETAIL 12**  
VALVE BOX LID MARKINGS  
NOT TO SCALE

SCOTT'S VALLEY WATER DISTRICT  
WWW.SVWD.ORG  
**DETAIL 5**  
2-INCH AND SMALLER SERVICE INSTALLATION  
NOT TO SCALE

SCOTT'S VALLEY WATER DISTRICT  
WWW.SVWD.ORG  
**DETAIL 14**  
STANDARD SERVICE LATERAL TRENCH  
NOT TO SCALE

SCOTT'S VALLEY WATER DISTRICT  
WWW.SVWD.ORG  
**DETAIL 15**  
STANDARD WATER MAIN TRENCH  
NOT TO SCALE




SCOTT'S VALLEY WATER DISTRICT  
WWW.SVWD.ORG  
**DETAIL 17**  
SYSTEM CONNECTION (TIE IN)  
NOT TO SCALE

SCOTT'S VALLEY WATER DISTRICT  
WWW.SVWD.ORG  
**DETAIL 18**  
JOINT RESTRAINT INSTALLATION  
NOT TO SCALE

Date: 09.29.2023  
Scale:  
Drawn: JB/IH/TC  
Job: 165.95  
Sheet:

**C3.1**  
Of 3 Sheets



By: amh/bjw

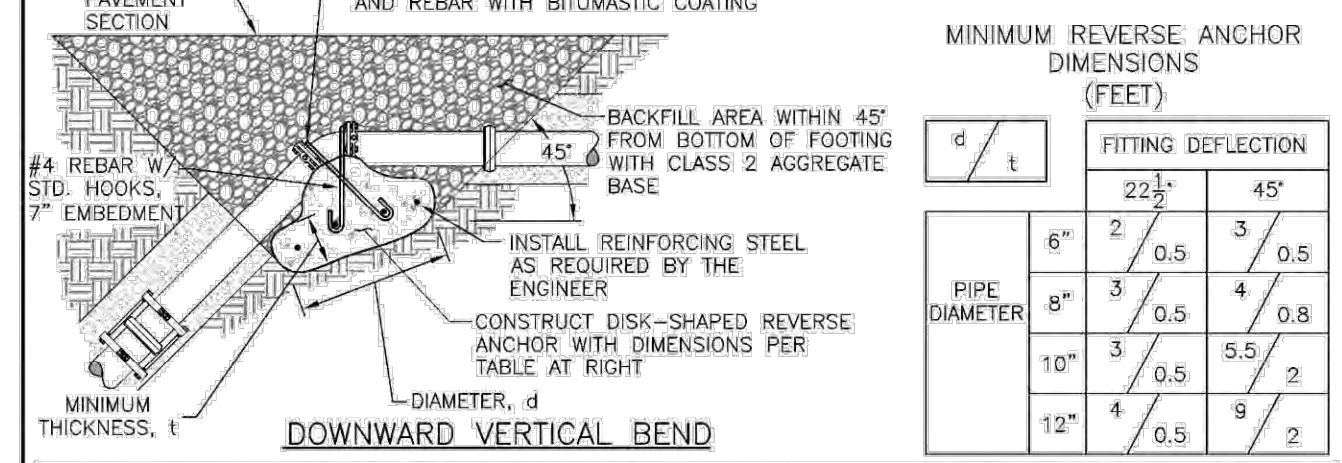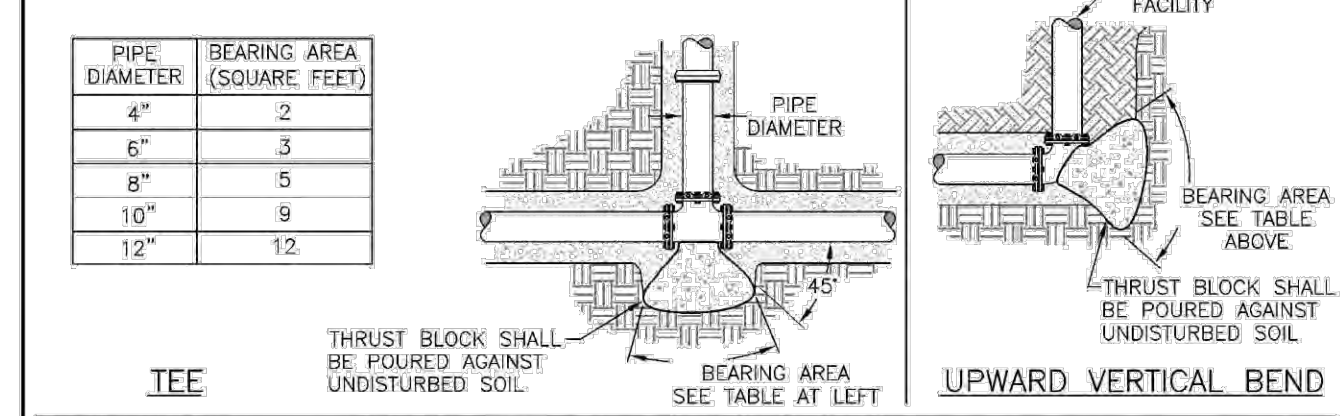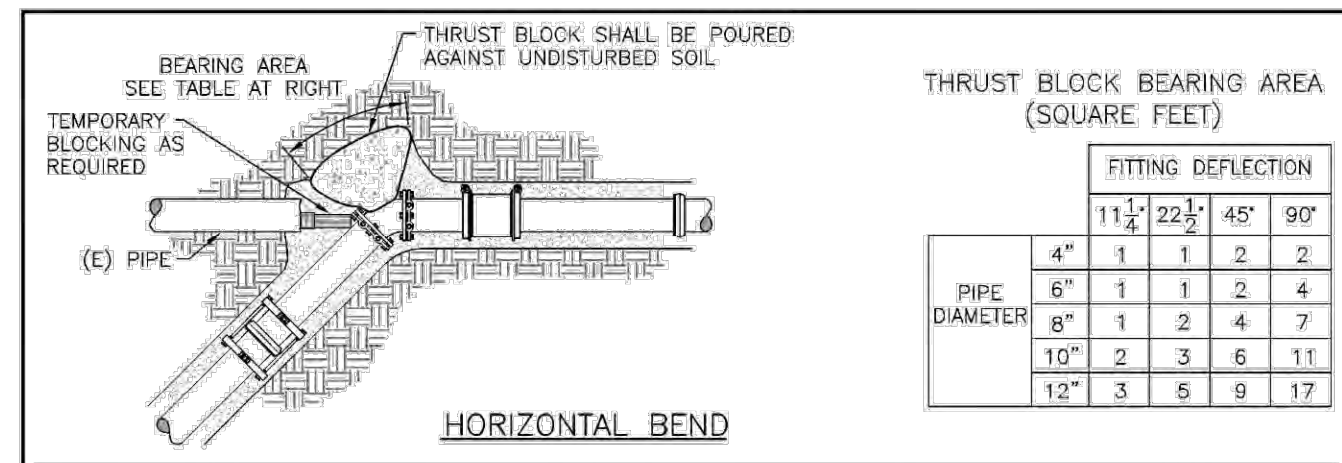

**NOTES**

- CONCRETE THRUST BLOCKS SHALL BE INSTALLED WHEN INDICATED BY THE CONTRACT DOCUMENTS OR AT THE DISCRETION OF THE ENGINEER.
- THRUST BLOCKING IS REQUIRED WHERE IT IS UNKNOWN IF PIPE IS RESTRAINED, SUCH AS AT A CONNECTION TO EXISTING PIPE.
- ALL CONCRETE SHALL BE 3000 PSI MINIMUM 28 DAYS COMPRESSIVE STRENGTH.
- FOR PIPELINES LARGER THAN 10" IN DIAMETER, PIPELINES INSTALLED AT DEPTHS LESS THAN 36 INCHES, OR IN POOR SOILS, THRUST BLOCK DESIGN SHALL BE APPROVED BY THE ENGINEER ON A CASE BY CASE BASIS.


**SCOTTS VALLEY WATER DISTRICT**  
www.svwd.org  
**DETAIL 19**  
THRUST BLOCK INSTALLATION  
NOT TO SCALE

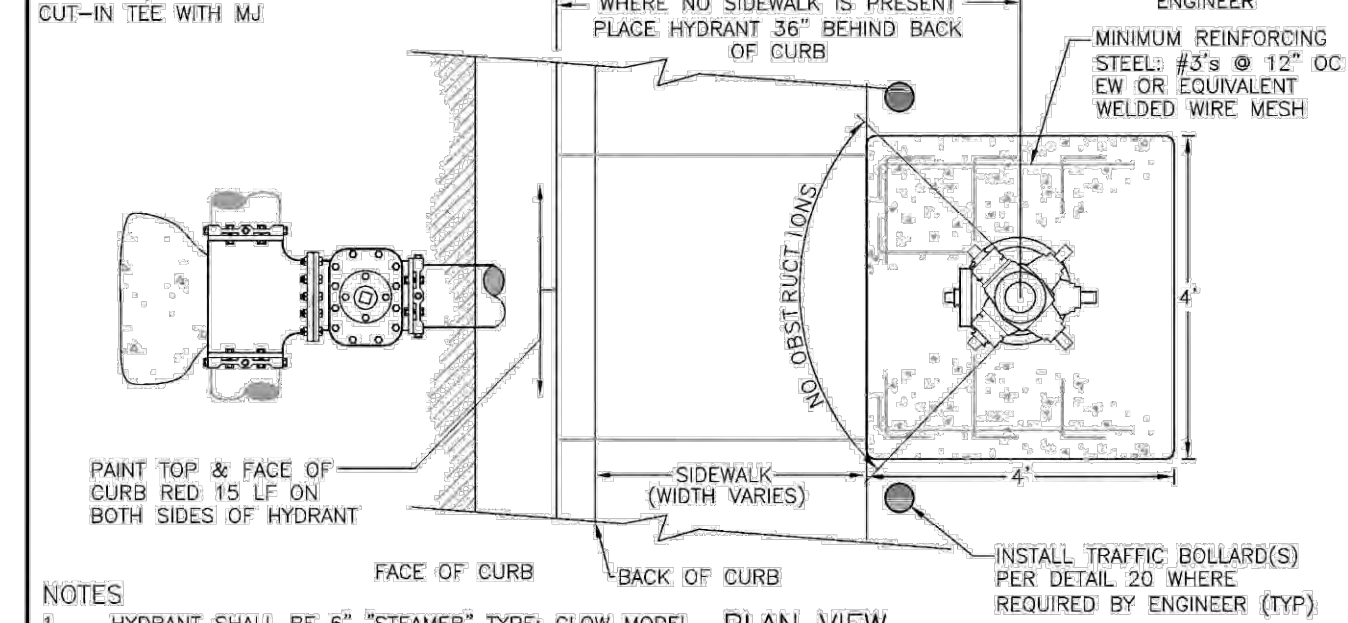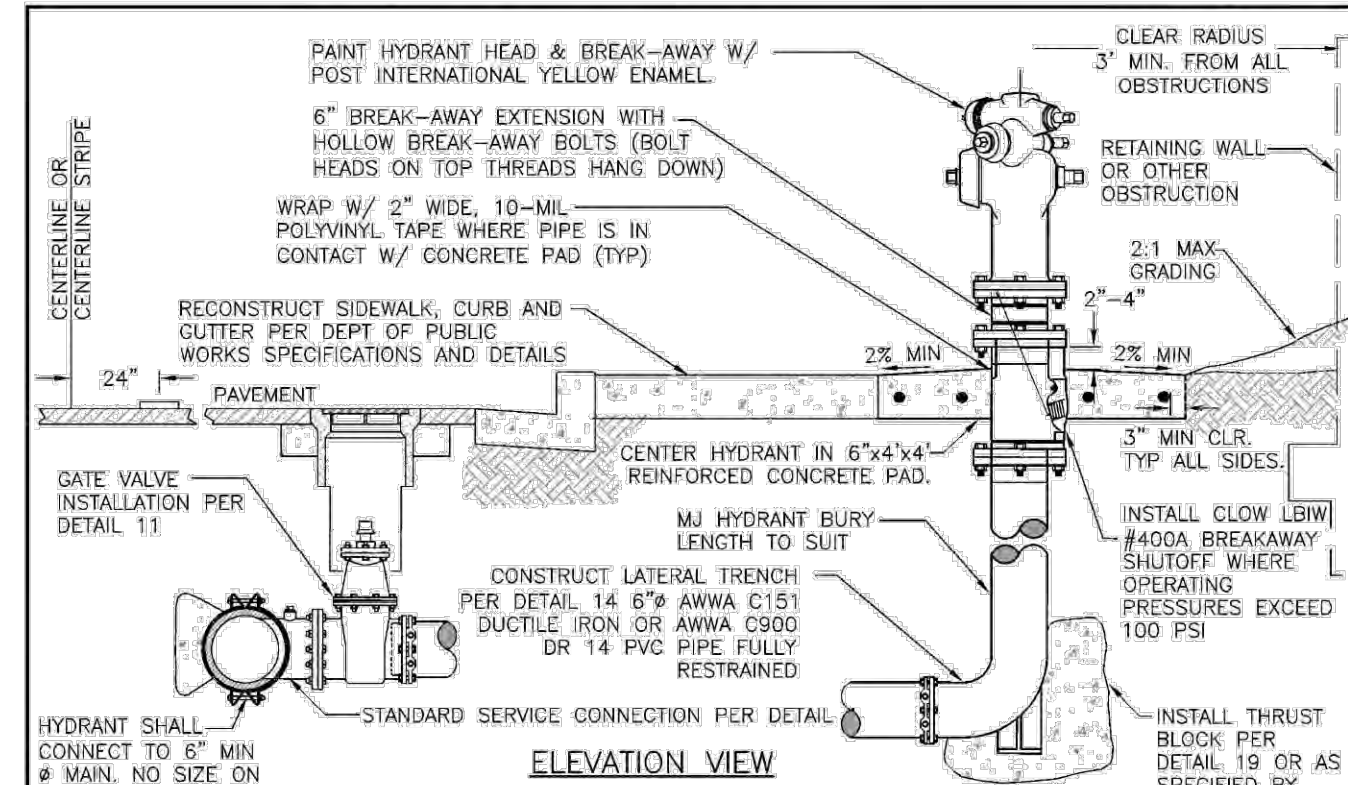


**NOTES**

- HYDRANT SHALL BE 6" STEAMER TYPE; CLOW MODEL 860, OR APPROVED EQUAL.
- REMOVE HYDRANT OUTLET CAP CHAINS PERMANENTLY.
- HYDRANT SHALL BE COVERED WITH BURLAP SACK OR APPROVED ORANGE BAG WHEN NOT IN SERVICE.
- FIRE HYDRANT LOCATION SHALL BE APPROVED ON A CASE BY CASE BASIS PRIOR TO CONSTRUCTION AND SHALL INCLUDE FIRE AGENCY APPROVED PLANS, CITY OR COUNTY ENCROACHMENT PERMIT, AND FIELD VERIFICATION BY THE APPROPRIATE FIRE AGENCY, CITY OR COUNTY PUBLIC WORKS DEPARTMENT AND SWWD, PER SWWD HYDRANT INSTALLATION PERMIT REQUIREMENTS PRIOR TO CONSTRUCTION. SEE APPENDIX 1 FOR FURTHER HYDRANT INSTALLATION REQUIREMENTS.

**SCOTTS VALLEY WATER DISTRICT**  
www.svwd.org  
**DETAIL 10**  
FIRE HYDRANT INSTALLATION  
NOT TO SCALE

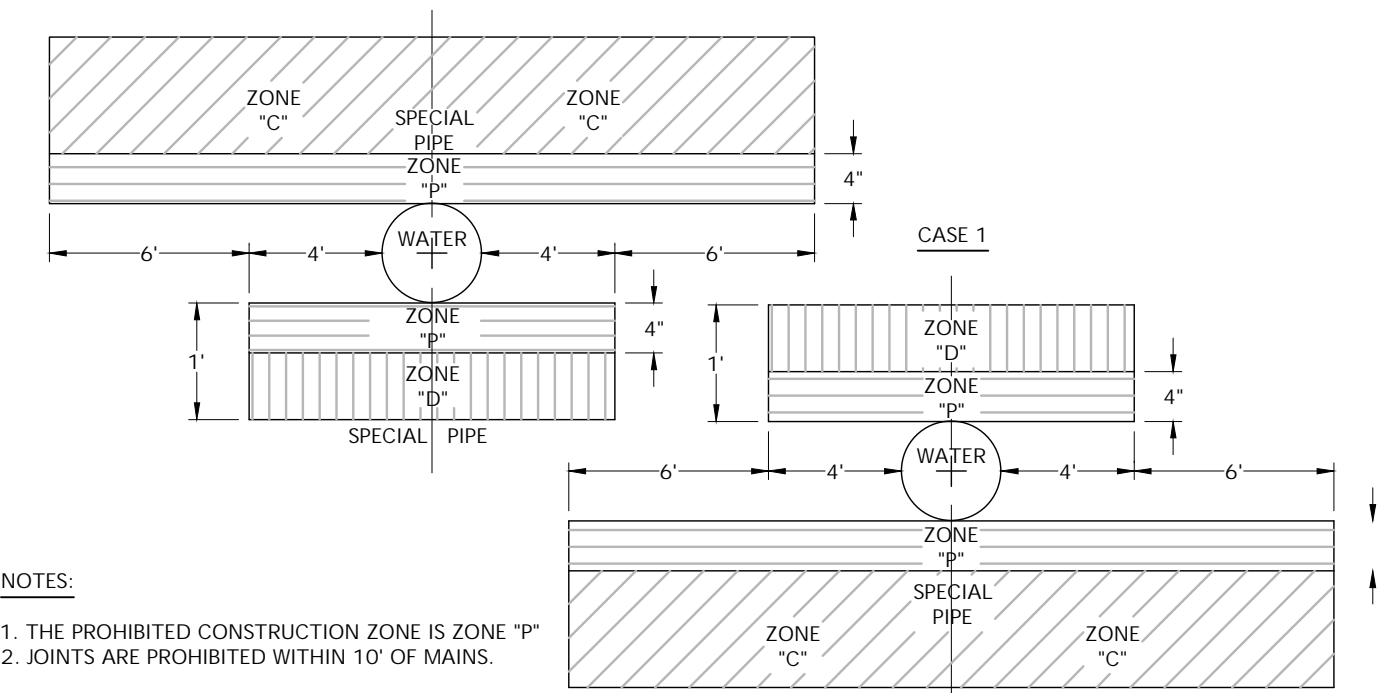

**3 STANDARD WATER SEWER CROSSING**  
Scale: NTS

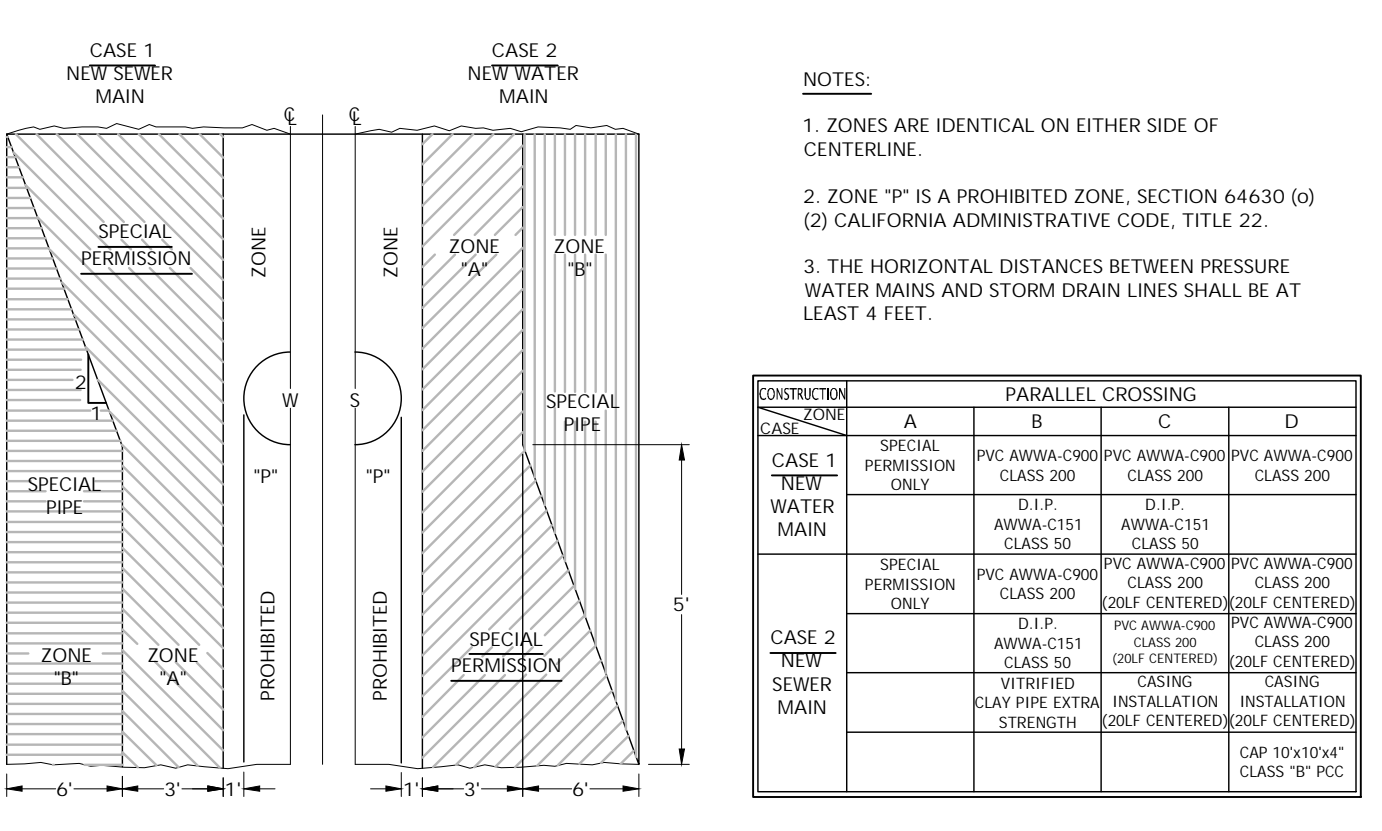

**4 STD PARALLEL CONSTRUCTION WATER SEWER**  
Scale: NTS

**PARALLEL CROSSING**

CONSTRUCTION ZONE	A	B	C	D
CASE 1 'NEW' WATER MAIN	SPECIAL PERMISSION ONLY	PVC AWWA-C900 CLASS 200	PVC AWWA-C900 CLASS 200	PVC AWWA-C900 CLASS 200
CASE 2 'NEW' SEWER MAIN	SPECIAL PERMISSION ONLY	D 12" AWWA-C151 CLASS 50	D 12" AWWA-C151 CLASS 50	PVC AWWA-C900 CLASS 200 (20' CENTERED) / 20" CLASS 200 (20' CENTERED)
		D 12" AWWA-C151 CLASS 50	D 12" AWWA-C151 CLASS 50	PVC AWWA-C900 CLASS 200 (20' CENTERED) / 20" CLASS 200 (20' CENTERED)
		AWWA-C151 CLASS 50	AWWA-C151 CLASS 50	PVC AWWA-C900 CLASS 200 (20' CENTERED) / 20" CLASS 200 (20' CENTERED)
		VITREOUS ENAMEL	GLASS	GLASS
		INSTALLATION	INSTALLATION	INSTALLATION
		20' CENTERED	20' CENTERED	20' CENTERED
		STRENGTH	STRENGTH	CLASS 'B' PCC

**REVISIONS**

NO.	DESCRIPTION	DATE	BY

**DETAILS**



**SCOTTS VALLEY WATER DISTRICT**  
www.svwd.org  
**DETAIL 19**  
THRUST BLOCK INSTALLATION  
NOT TO SCALE

**SCOTTS VALLEY WATER DISTRICT**  
BETHANY DRIVE  
WATER MAIN IMPROVEMENTS

Date: 09.29.2023  
Scale:  
Drawn: JB/IH/TC  
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Sheet:  
**C3.2**  
Of 3 Sheets